


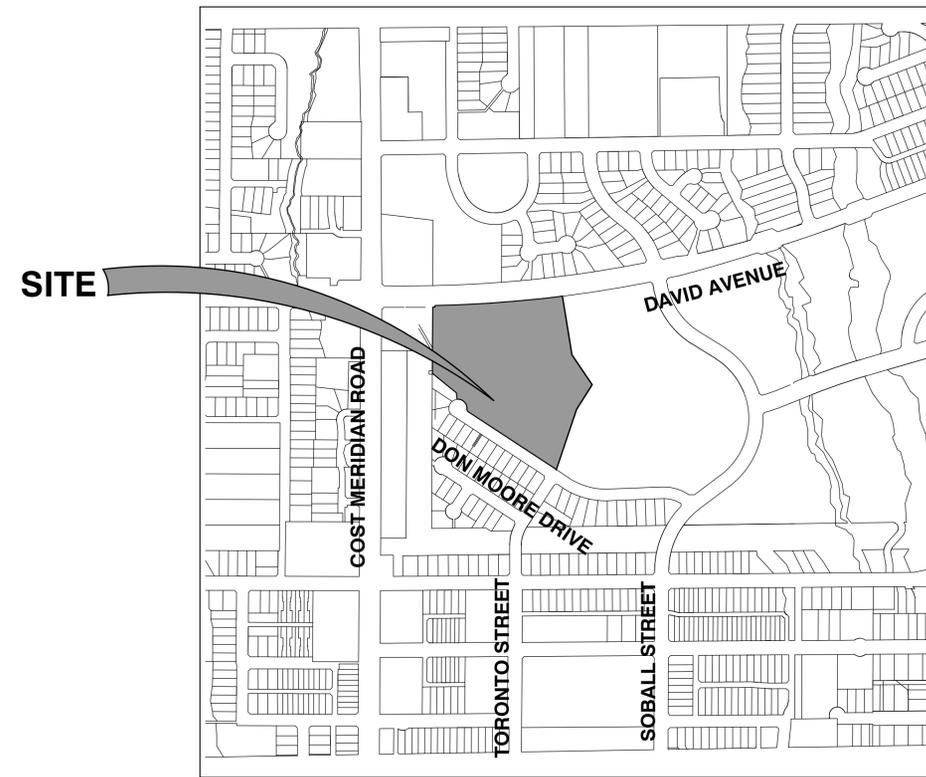

EGBC Permit to Practice Number #1001018
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SITE LOCATION PLAN

SCALE - 1:5000

PROPERTY OWNER:

- CITY OF COQUITLAM

CLIENT:

CITY OF COQUITLAM

3000 GUILDFORD WAY, COQUITLAM, BC, V3B 7N2
 604-939-9201

PROJECT:

BURKE MOUNTAIN ATHLETIC PARK

3390 & 3400 DAVID AVENUE, COQUITLAM, BC V3E 0B8

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02	STANDARD NOTES
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04	PARK SITE KEY PLAN
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06	GRADING PLAN - SOUTH
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MUNICIPAL PROJECT No. PROJ 25-015

APLIN & MARTIN PROJECT No. 18-264A

GENERAL NOTES:

- CONTRACTOR TO VERIFY THE LOCATION AND INVERTS OF EXISTING WATER, STORM AND SANITARY CONNECTIONS TO THE SITE. REPORT TO THE ENGINEER ANY DISCREPANCIES PRIOR TO START OF CONSTRUCTION.
- ALL BUILDINGS & ROADS ARE TO BE LOCATED BY CO-ORDINATES AS CALCULATED BY A B.C. LAND SURVEYOR.
- THE CONTRACTOR MUST CONTACT THE ENGINEER PRIOR TO CONSTRUCTION TO SCHEDULE AN ON-SITE PRE-CONSTRUCTION MEETING DURING WHICH CONSTRUCTION METHODS, TIMING, AND INSPECTION WILL BE DISCUSSED.
- ALL WORKS TO BE IN ACCORDANCE WITH THE BC BUILDING CODE 2024 AND MMCD PLATINUM EDITION.
- CONSULT GAS CONSULTANT FOR GAS DISTRIBUTION WITHIN THE SITE.
- CONSULT BC HYDRO DRAWINGS FOR HYDRO DISTRIBUTION WITHIN SITE.
- CONSULT ELECTRICAL DRAWINGS FOR DISTRIBUTION WITHIN SITE.
- LANDSCAPED AREAS REQUIRE THE FOLLOWING MINIMUM TOPSOIL DEPTHS:
 - LAWN AREAS: 300mm
 - SHRUB AREAS: 450mm
 - TREE PITS: 900mm
 IF THERE ARE DISCREPANCIES BETWEEN THESE DRAWINGS AND THE LANDSCAPE DRAWINGS THE LANDSCAPE DRAWINGS WILL GOVERN.

LOT GRADING:

- ALL DIMENSIONS AND ELEVATIONS ARE IN METERS UNLESS OTHERWISE NOTED.
- ALL ELEVATIONS ARE TO GEODETIC DATUM.
- ALL CONSTRUCTION IS TO BE IN ACCORDANCE WITH MMCD PLATINUM EDITION, 2024 B.C. BUILDING AND PLUMBING CODES AND IS TO BE ACCEPTABLE TO THE CITY OF COQUITLAM BUILDING AND PERMITS DEPARTMENT.
- ALL EXCAVATION, FILL PLACEMENT AND COMPACTION TO BE IN ACCORDANCE WITH GEOTECHNICAL CONSULTANTS REPORT.
- CONTRACTOR TO EMPLOY GEOTECHNICAL CONSULTANT FOR PERFORMANCE OF IN PLACE TESTING DURING THE PREPARATION OF THE SUBGRADE AND CONSTRUCTION OF THE ROAD STRUCTURE TO VERIFY THE ADEQUACY OF PROPOSED ROAD STRUCTURE AND SUBGRADE.
- CHANGES TO GRADE SHALL BE FORMED BY SMOOTH CURVES.

COQUITLAM CONSTRUCTION NOTES:

- ALL WORK AND MATERIALS SHALL COMPLY WITH THE CITY OF COQUITLAM'S MARCH 2022 SUPPLEMENTARY SPECIFICATIONS AND DETAILED DRAWINGS TO THE MMCD - 2009 PLATINUM EDITION.
- THE PARKS PLANNING SECTION IS TO BE CONTACTED WHEN THE ENGINEERING PRE-CONSTRUCTION MEETING IS TO TAKE PLACE SO THAT A REPRESENTATIVE CAN BE SENT TO THE MEETING TO DISCUSS THE TRACKS AND FIELD WORKS.
- ALL TESTING, INCLUDING COMPACTION AND CONCRETE TESTING, TO BE CONDUCTED BY THE CONTRACTOR.

STORM SEWER NOTES:

- ALL STORM SEWER & BEDDING MATERIALS TO MEET MASTER MUNICIPAL CONTRACT DOCUMENTS (MMCD) PLATINUM & BRITISH COLUMBIA PLUMBING CODE 2018 REQUIREMENTS.
- ALL MANHOLES TO BE SIZED AS PER MMCD STD. DWG. S1 AND SHALL BE PRE-CAST REINFORCED CONCRETE TO ASTM C478.
- CATCH BASINS ARE TO CONFORM TO MMCD DWG. S11.
- ALL CATCH BASIN LEADS ARE TO BE 150mmØ AT MINIMUM 0.75% SLOPE UNLESS OTHERWISE NOTED.
- ALL LAWN BASINS TO BE 600Ø OPEN BOTTOM AND SHALL CONFORM TO MMCD STANDARDS.
- ALL LAWN BASIN LEADS ARE TO BE 100mmØ AT MINIMUM 1.00% SLOPE UNLESS OTHERWISE NOTED.
- CONTRACTOR TO CAP ALL SERVICE CONNECTIONS AT LOCATIONS COORDINATED WITH MECHANICAL DESIGN. STORM AND SANITARY CONNECTIONS TO BE RAISED WITH VERTICAL STAND PIPES TO MINIMUM 1.0m ABOVE GRADE AND MARKED.
- CONTRACTOR TO CONFIRM LOCATION AND INVERTS OF EXISTING STORM AND SANITARY SEWER CONNECTIONS PRIOR TO CONSTRUCTION.
- STORM SEWER PIPES TO BE PVC SDR28 UPTO 150Ø, PVC SDR35 TILL 600Ø, AND CONCRETE C76 CLASS IV ABOVE 600Ø.
- STORM AND SANITARY SEWERS TO HAVE 0.6m MINIMUM COVER.
- SCHEDULE 40 AND/OR SCHEDULE 80 PLASTIC PIPE SHALL NOT BE USED FOR ANY SITE APPLICATION IN THE CIVIL WORK.
- ALL CLEANOUTS TO CONFORM TO MMCD DWG. S6.
- LEADS TO BE INSTALLED AT SHOWN SLOPE WITH LONG RADIUS BEND(S), AS REQUIRED.
- CONTRACTOR SHALL PROVIDE VIDEO INSPECTION OF ALL COMPLETED STORM WORKS FOR MAINS OF ALL SIZES TO OFFSITE STORM CONNECTION LOCATION. VIDEO INSPECTION TO BE COMPLETED IN ACCORDANCE WITH MMCD PLATINUM SPECIFICATIONS.
- INSPECTION AND TESTING AS PER MMCD PLATINUM SPECIFICATIONS.
- CONTRACTOR SHALL, AS PART OF THE BASE CONTRACT, BE RESPONSIBLE TO CLEAN ALL STORM SEWERS JUST PRIOR TO THE TURNOVER OF THE SITE TO THE OWNER.

WATERWORKS NOTES:



- ALL WATERMAIN END BEDDING TO MEET MASTER MUNICIPAL CONTRACT DOCUMENTS (MMCD) PLATINUM AND BRITISH COLUMBIA PLUMBING CODE 2024 REQUIREMENTS.
- CURB STOPS TO BE FITTED WITH SERVICE BOXES AS PER MMCD W2b.
- TIE-INS TO EXISTING WATER MAINS AND FINAL TESTING AND CHLORINATION OF NEW MAINS IS TO BE PERFORMED BY THE CONTRACTOR.
- FIRE HYDRANTS TO BE AS PER MMCD W4 WITH "STORZ" QUICK CONNECTION. (OFF-SITE)
- THE CONTRACTOR SHOULD INCLUDE TESTING AS PER MMCD DRAWINGS AND SPECIFICATIONS.
- DOMESTIC WATERMAINS TO BE HDPE DR9 IN COMPLIANCE WITH AWWA C901 OR APPROVED EQUIVALENT AND CERTIFIED TO CAN/CSA B137.1
- MINIMUM GRADE OF WATER MAIN TO BE 0.10%.
- BUTT FUSION FITTINGS SHALL BE MADE OF HDPE MATERIAL WITH A MIN. MATERIAL DESIGNATION CODE OF PE4710. BUTT FUSION FITTINGS SHALL MEET THE REQUIREMENTS OF ASTM D3261 AND CERTIFIED TO SERIES 200 OF CAN/CSA B137.1
- ALL WATERMAIN JOINTS TO BE WRAPPED WITH "ENVIROTAPE" AS PER CITY STANDARDS AND SPECIFICATIONS AND MINISTRY OF HEALTH REQUIREMENTS IN LOCATIONS WHERE THE HORIZONTAL CENTERLINE DISTANCE BETWEEN THE WATERMAIN ALIGNMENT AND THE STORM SEWER AND/OR SANITARY SEWER ALIGNMENT IS LESS THAN 3.00m.

TESTING SUBMITTALS AND INSPECTION:

- CONTRACTOR TO PROVIDE SHOP DRAWING SUBMITTALS INCLUDING BUT NOT LIMITED TO THE FOLLOWING:
 - SEWER PIPES, CATCH BASINS, LAWN BASINS, AND MANHOLES
 - CASING PIPE AND SPACER DETAILS
 - WATER PIPES AND FITTINGS
 - WATER METER CHAMBERS
- CONTRACTOR TO PROVIDE TESTING SUBMITTALS FOR THE FOLLOWING:
 - SANITARY & STORM
 - PIPE BEDDING SIEVE & PROCTORS
 - IMPORTED BACKFILL SIEVE & PROCTORS
 - SUB-GRADE DENSITIES
 - TRENCH SUBBASE & BASE SIEVE & PROCTORS
 - TRENCH SUBBASE & BASE DENSITIES
 - CCTV VIDEO & REPORTS OF ALL SEWERS (INCLUDING SERVICE CONNECTIONS, CATCH BASIN LEADS, AND LAWN BASIN LEADS)
 - AIR TESTS (SANITARY ONLY)
 - WATER
 - WATER PRESSURE TEST
 - WATER FLUSHING & CHLORINATION REPORT
 - BACTERIOLOGICAL/BUG TEST
 - BACKFLOW PREVENTER TEST RESULTS
 - WATER METER CHAMBER INSTALLATION REPORT
 - PLUMBING INSPECTION TICKET
 - CONTRACTOR'S MATERIAL AND TEST REPORT FOR UNDERGROUND PIPING
 - ROADWORKS
 - CURBS & SIDEWALKS SUBBASE & BASE DENSITIES
 - CURBS, SIDEWALKS, LETDOWNS AND DRIVEWAYS CONCRETE TEST
 - CURBS PROOF ROLL
 - ROAD SUBBASE & BASE SIEVE & PROCTORS
 - ROAD SUBBASE & BASE DENSITIES
 - ASPHALT BASE & OVERLAY DENSITIES
 - ASPHALT MARSHALL TEST AND CORES
 - CONCRETE REINFORCEMENT
 - LIGHTING
 - STREETLIGHT POLES, BASE, & LUMINAIRES
 - SERVICE PANEL AND JUNCTION BOXES
 - LIGHTING CONDUIT AND CONDUCTOR PRODUCT DATA
 - ANY OTHER MATERIAL TESTING REQUIREMENTS NOTED ON THE ISSUED FOR CONSTRUCTION DRAWINGS ARE TO ALSO BE SUBMITTED.
- CONTRACTOR TO PROVIDE CIVIL CONSULTANT WITH CONSTRUCTION SCHEDULE (INCLUDING TESTING) FOR ALL CIVIL CONSTRUCTION WORKS SO CIVIL CONSULTANT CAN COORDINATE INSPECTIONS ACCORDINGLY.

LEGEND FOR CONSTRUCTION DRAWINGS

PROPOSED	EXISTING	DESCRIPTION
		TEST HOLES
		IRON PROPERTY PIN
		BENCH MARK - GEODETIC DATUM
		EDGE OF PAVEMENT
		CURB & GUTTER
		SANITARY SEWER
		SANITARY CONNECTION & INSPECTION CHAMBER
		STORM SEWER
		STORM CONNECTION & INSPECTION CHAMBER
		STORM SEWER SERVICE
		FRENCH DRAIN
		CATCH BASIN - TOP INLET & SIDE INLET
		LAWN DRAIN
		SWALE
		DITCH
		SIDEWALK (ASPHALT)
		SIDEWALK (CONCRETE)
		WATERMAIN
		WATER SERVICE CONNECTION
		WATER VALVE
		AIR VALVE
		HYDRANT & VALVE ASSEMBLY
		CAPPED END
		WATER METER
		BLOW-OFF
		UNDERGROUND TELEPHONE & MANHOLE
		UNDERGROUND ELECTRICAL & MANHOLE
		GASMAIN
		TRAFFIC SIGNAL & STREET LIGHT U/G DUCTS
		ORNAMENTAL STREET LIGHT - DAVIT
		ORNAMENTAL STREET LIGHT - POST TOP
		UTILITY POLE
		UTILITY POLE W/LIGHT
		JUNCTION BOX
		FUTURE PROPOSED PUMP CONNECTIONS

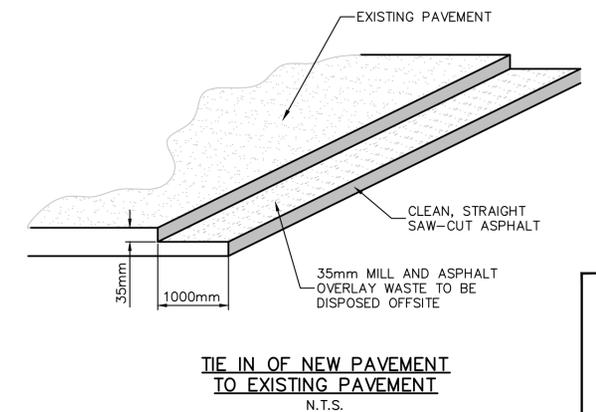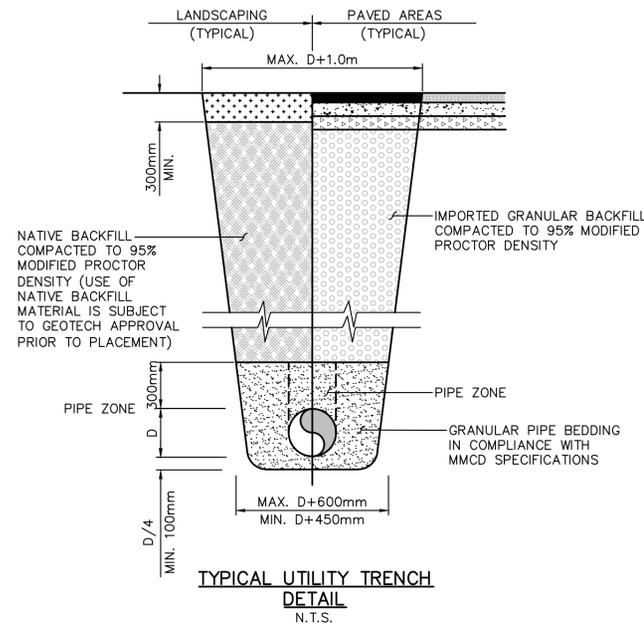

Edge of pavement	Hydrant	Sanitary service	Hydro Guy Wire
Watermain and valve	Water air valve	Sanitary cleanout	Hydro Kiosk
Drainage sewer, MH	Water blowoff	Utility pole (joint pole)	Vegetation Conifer
Drainage ditch	Water service	Utility pole with light	Vegetation Deciduous
Sanitary sewer, MH	Catch basin, top inlet	Streetlight, davit	Vegetation Shrub
Sanitary forcemain	Catch basin, side inlet	Streetlight, post top	Survey Traverse Hub
Gasmain and valve	Catch basin, round	Comb signal pole	Survey Iron Pin
Hydro duct, MH	Drainage service	Traffic signal pole	Survey Lead Plug
Telephone duct, MH	Drainage cleanout	Junction box	Survey Monument

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2	2024-07-10	RJB	ISSUED FOR ALTERNATIVE COSTING
1	2024-05-08	RJB	ISSUED FOR 75% REVIEW

Design by: **ASB** Date: **MAY, 2024**

Drawn by: **ASB** Date: **MAY, 2024**

Checked by: **RJB** Date: **MAY, 2024**

Approved by: **RJB** Date: **MAY, 2024**

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Date: _____
Manager of Development Servicing

Coquitlam
Engineering & Public Works
3000 Guildford Way, Coquitlam, B.C. V3B 7N2


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Sheet of **02 of 26**
Eng. Project No. **PROJ 25-015**

Project: **BURKE MOUNTAIN ATHLETIC PARK**

Description: **STANDARD NOTES**

File: **18-264A**

May 05 2025 - 11:42am MA_SUP-LD\18-2644\DWG\ONSITE - PRODUCTION\18-2644 - KEY PLAN.dwg/03 MASTER SITE KEY PLAN

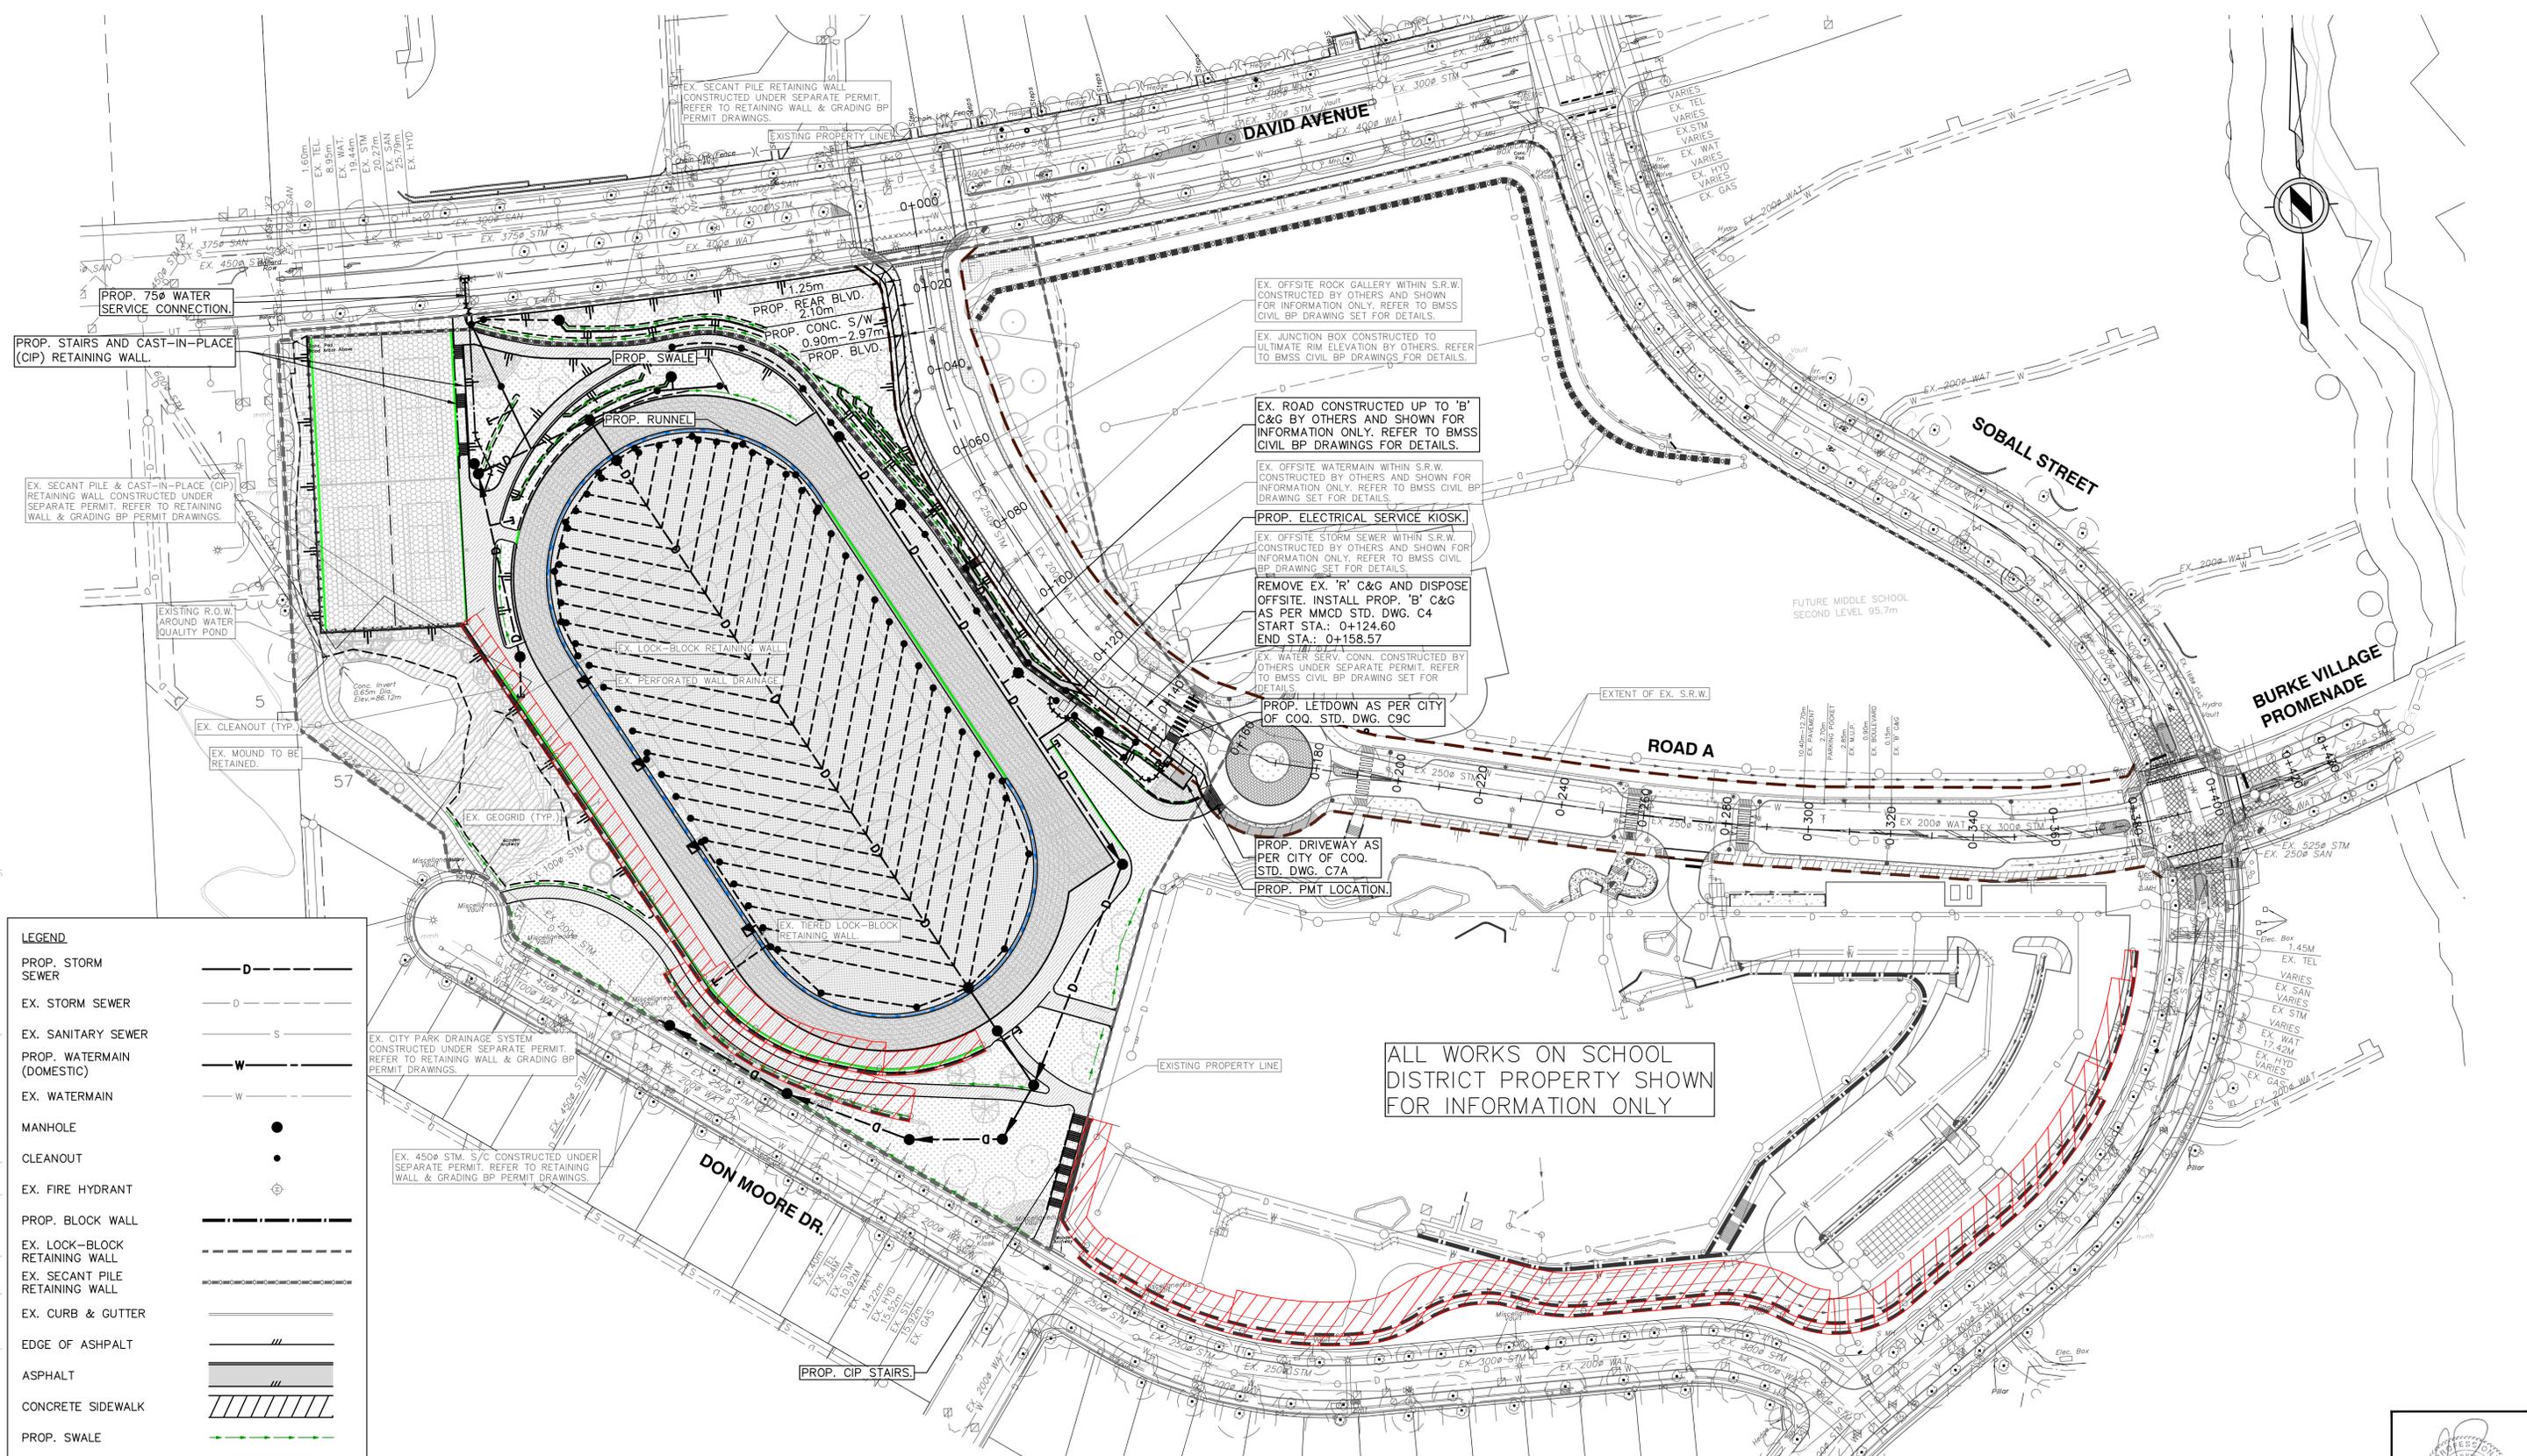

LEGEND

PROP. STORM SEWER	D
EX. STORM SEWER	-D-
EX. SANITARY SEWER	S
PROP. WATERMAIN (DOMESTIC)	W
EX. WATERMAIN	-W-
MANHOLE	●
CLEANOUT	•
EX. FIRE HYDRANT	⊕
PROP. BLOCK WALL	—
EX. LOCK-BLOCK RETAINING WALL	- - -
EX. SECANT PILE RETAINING WALL	—
EX. CURB & GUTTER	—
EDGE OF ASPHALT	—
ASPHALT	—
CONCRETE SIDEWALK	—
PROP. SWALE	—
EXISTING GEOGRID	—
PROP. RUNNEL	—
PROP. TRENCH DRAIN	—

EX. CITY PARK DRAINAGE SYSTEM CONSTRUCTED UNDER SEPARATE PERMIT. REFER TO RETAINING WALL & GRADING BP PERMIT DRAWINGS.

EX. 450# STM. S/C CONSTRUCTED UNDER SEPARATE PERMIT. REFER TO RETAINING WALL & GRADING BP PERMIT DRAWINGS.

LEGAL DESCRIPTION: LOT 2 AND LOT 3, BOTH OF SECTION 7 AND 18 TOWNSHIP 40 NEW WESTMINSTER DISTRICT PLAN BCP36982

ELEVATIONS DERIVED FROM CONTROL MONUMENT 75H3703 LOCATED NEAR THE CENTERLINE OF MASON AVENUE, CLOSE TO WEST BARRIER ELEVATION: 67.606m

EX. OFFSITE ROCK GALLERY WITHIN S.R.W. CONSTRUCTED BY OTHERS AND SHOWN FOR INFORMATION ONLY. REFER TO BMSS CIVIL BP DRAWING SET FOR DETAILS.

EX. JUNCTION BOX CONSTRUCTED TO ULTIMATE RIM ELEVATION BY OTHERS. REFER TO BMSS CIVIL BP DRAWINGS FOR DETAILS.

EX. ROAD CONSTRUCTED UP TO 'B' C&G BY OTHERS AND SHOWN FOR INFORMATION ONLY. REFER TO BMSS CIVIL BP DRAWINGS FOR DETAILS.

EX. OFFSITE WATERMAIN WITHIN S.R.W. CONSTRUCTED BY OTHERS AND SHOWN FOR INFORMATION ONLY. REFER TO BMSS CIVIL BP DRAWING SET FOR DETAILS.

PROP. ELECTRICAL SERVICE KIOSK.

EX. OFFSITE STORM SEWER WITHIN S.R.W. CONSTRUCTED BY OTHERS AND SHOWN FOR INFORMATION ONLY. REFER TO BMSS CIVIL BP DRAWING SET FOR DETAILS.

REMOVE EX. 'R' C&G AND DISPOSE OFFSITE. INSTALL PROP. 'B' C&G AS PER MMCD STD. DWG. C4 START STA.: 0+124.60 END STA.: 0+158.57

EX. WATER SERV. CONN. CONSTRUCTED BY OTHERS UNDER SEPARATE PERMIT. REFER TO BMSS CIVIL BP DRAWING SET FOR DETAILS.

PROP. LETDOWN AS PER CITY OF COQ. STD. DWG. C9C

PROP. DRIVEWAY AS PER CITY OF COQ. STD. DWG. C7A

PROP. PMT LOCATION.

ALL WORKS ON SCHOOL DISTRICT PROPERTY SHOWN FOR INFORMATION ONLY

Edge of pavement	Hydrant	Sanitary service	Hydro Guy Wire
Watermain and valve	Water air valve	Sanitary cleanout	Hydro Kiosk
Drainage sewer, MH	Water blowoff	Utility pole(joint pole)	Vegetation Conifer
Drainage ditch	Water service	Utility pole with light	Vegetation Deciduous
Sanitary sewer, MH	Catch basin, top inlet	Streetlight, davit	Vegetation Shrub
Sanitary forcemain	Catch basin, side inlet	Streetlight, post top	Survey Traverse Hub
Gasmain and valve	Catch basin, round	Comb signal pole	Survey Iron Pin
Hydro duct, MH	Drainage service	Traffic signal pole	Survey Lead Plug
Telephone duct, MH	Drainage cleanout	Junction box	Survey Monument

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Approved by: RJB Date: MAY, 2024

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ACCEPTED FOR CONSTRUCTION Date: _____ Manager of Development Servicing

Coquitlam

Engineering & Public Works

3000 Guildford Way, Coquitlam, B.C. V3B 7N2

Scale horz. 1:750 Scale vert. N/A

Sheet of **03 of 26**

Eng. Project No. **PROJ 25-015**


Project: **BURKE MOUNTAIN ATHLETIC PARK**

Description: **MASTER SITE KEY PLAN**

File: 18-264A




NOT FOR CONSTRUCTION

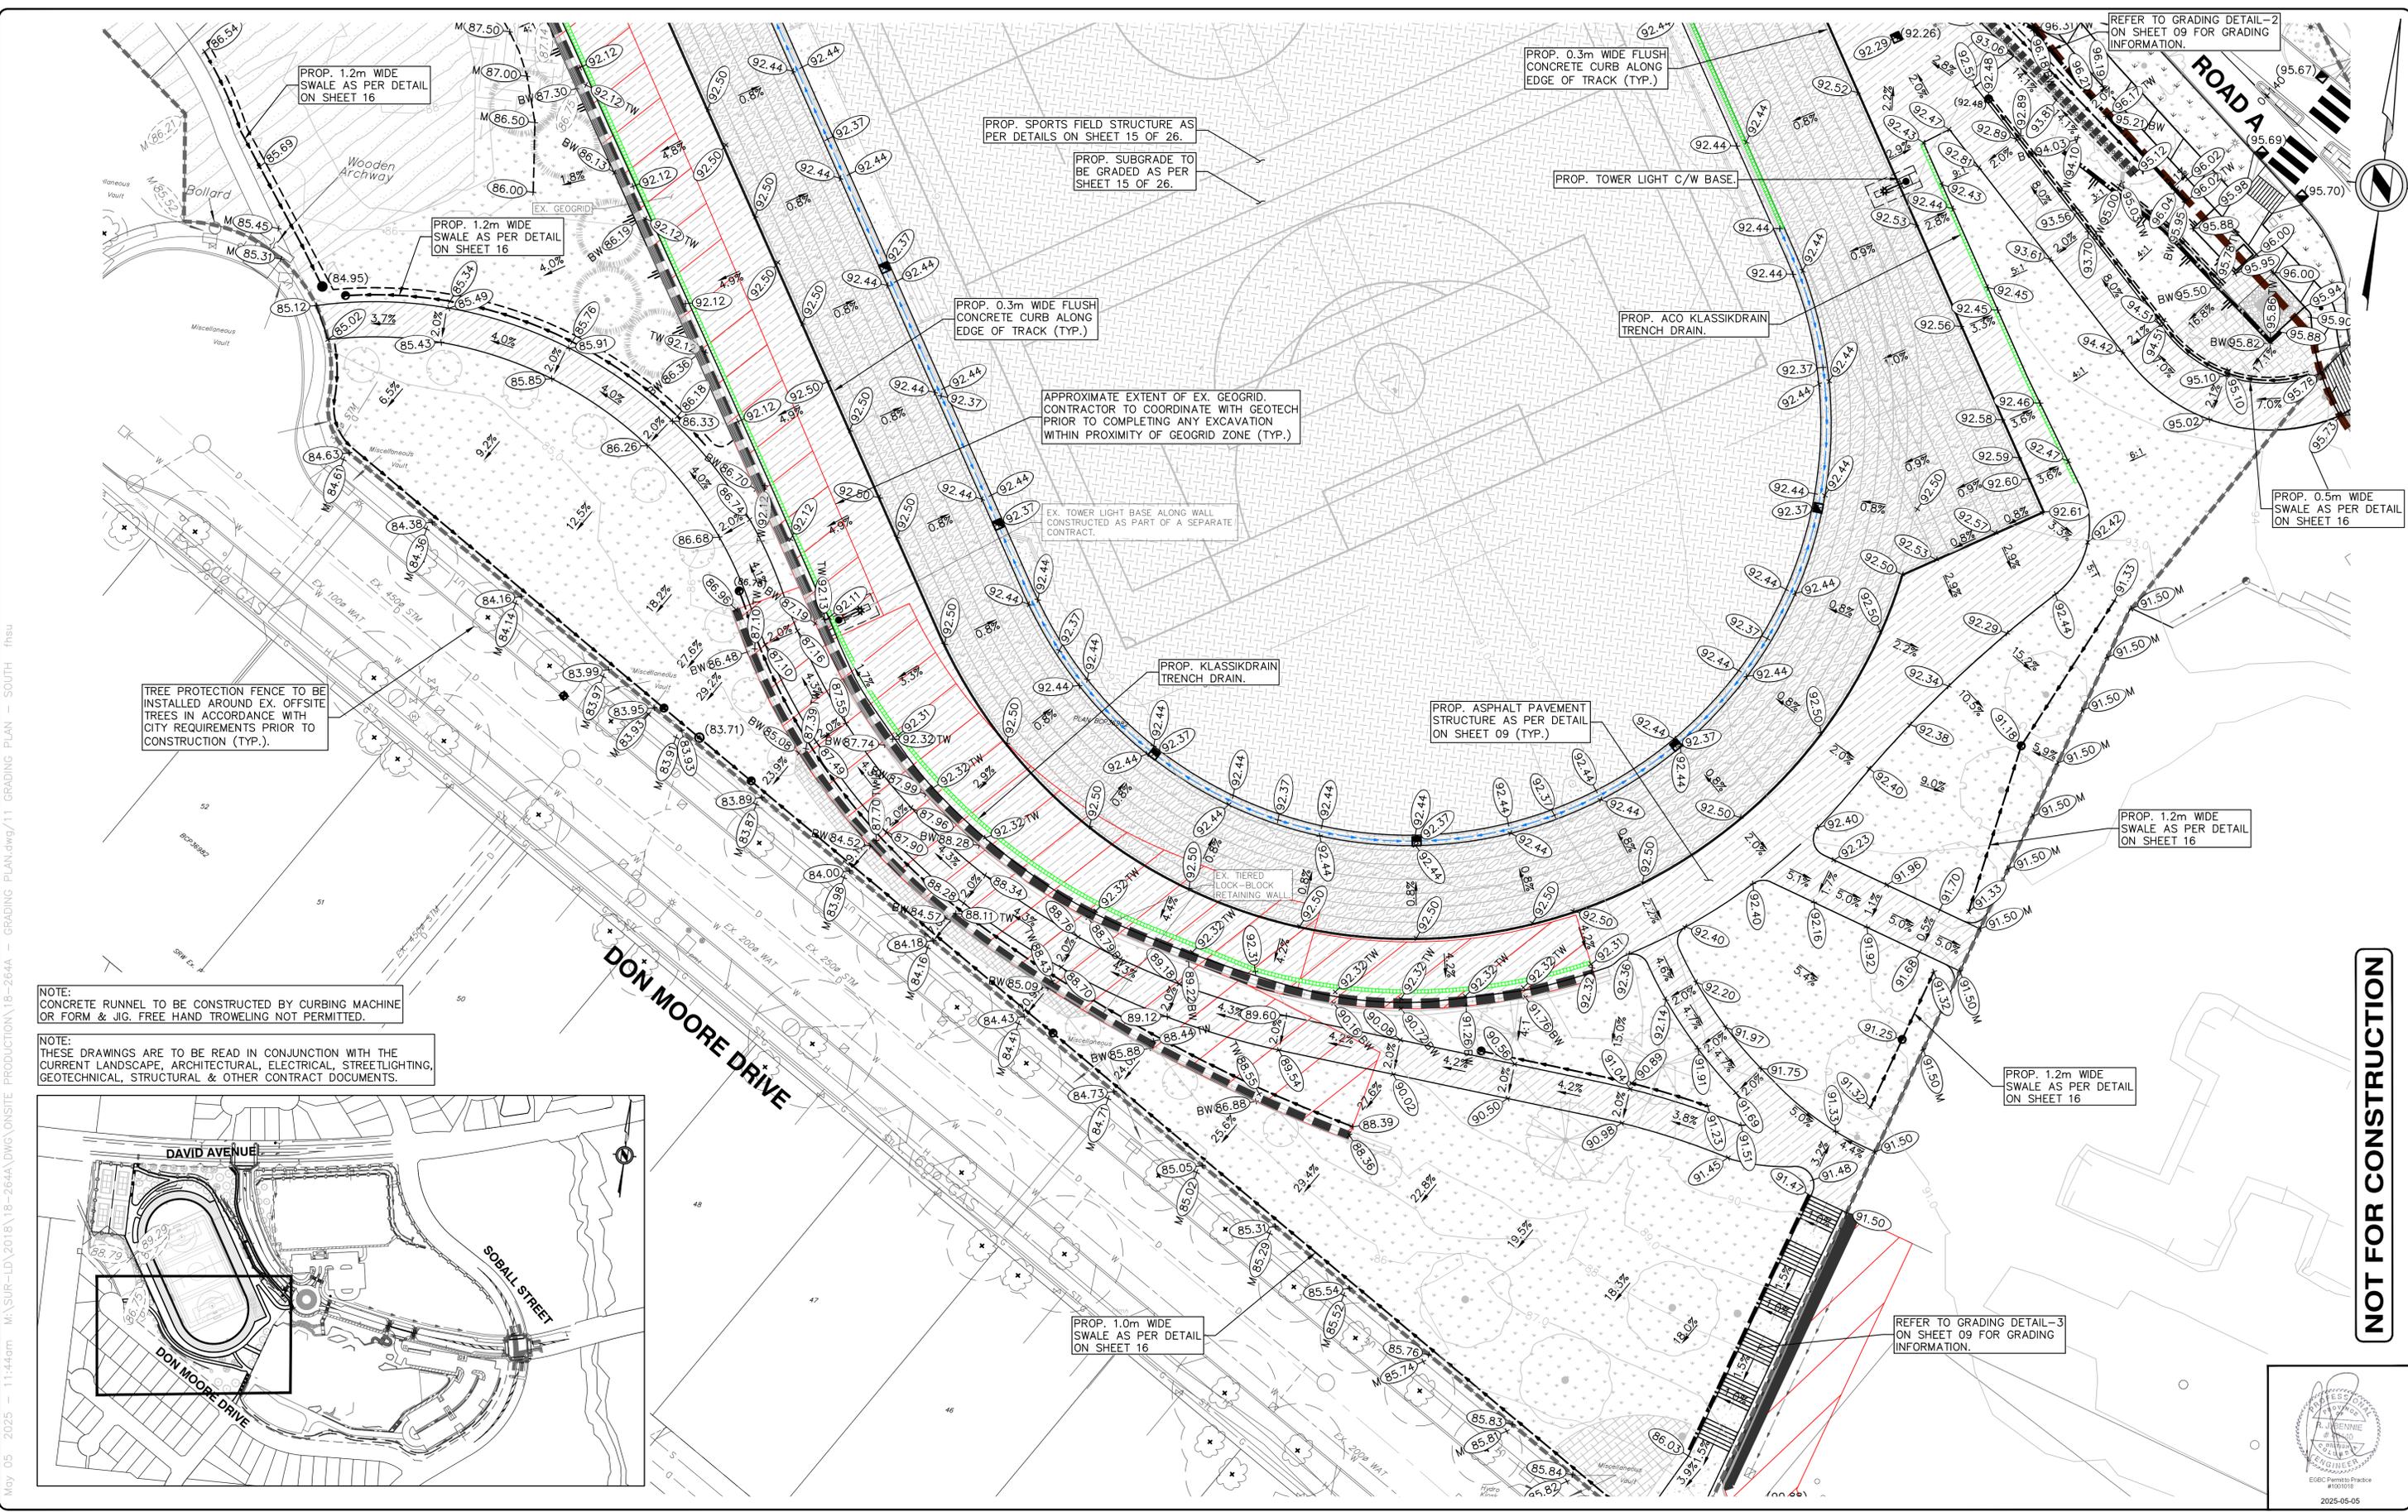

NOTE:
CONCRETE RUNNEL TO BE CONSTRUCTED BY CURBING MACHINE OR FORM & JIG. FREE HAND TROWELING NOT PERMITTED.

NOTE:
THESE DRAWINGS ARE TO BE READ IN CONJUNCTION WITH THE CURRENT LANDSCAPE, ARCHITECTURAL, ELECTRICAL, STREETLIGHTING, GEOTECHNICAL, STRUCTURAL & OTHER CONTRACT DOCUMENTS.

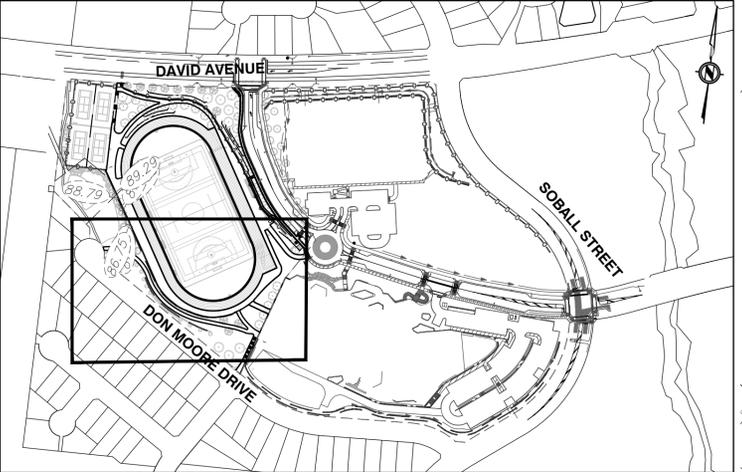

NOT FOR CONSTRUCTION

Edge of pavement	Hydrant	Sanitary service	Hydro Guy Wire
Watermain and valve	Water air valve	Sanitary cleanout	Hydro Kiosk
Drainage sewer, MH	Water blowoff	Utility pole (joint pole)	Vegetation Conifer
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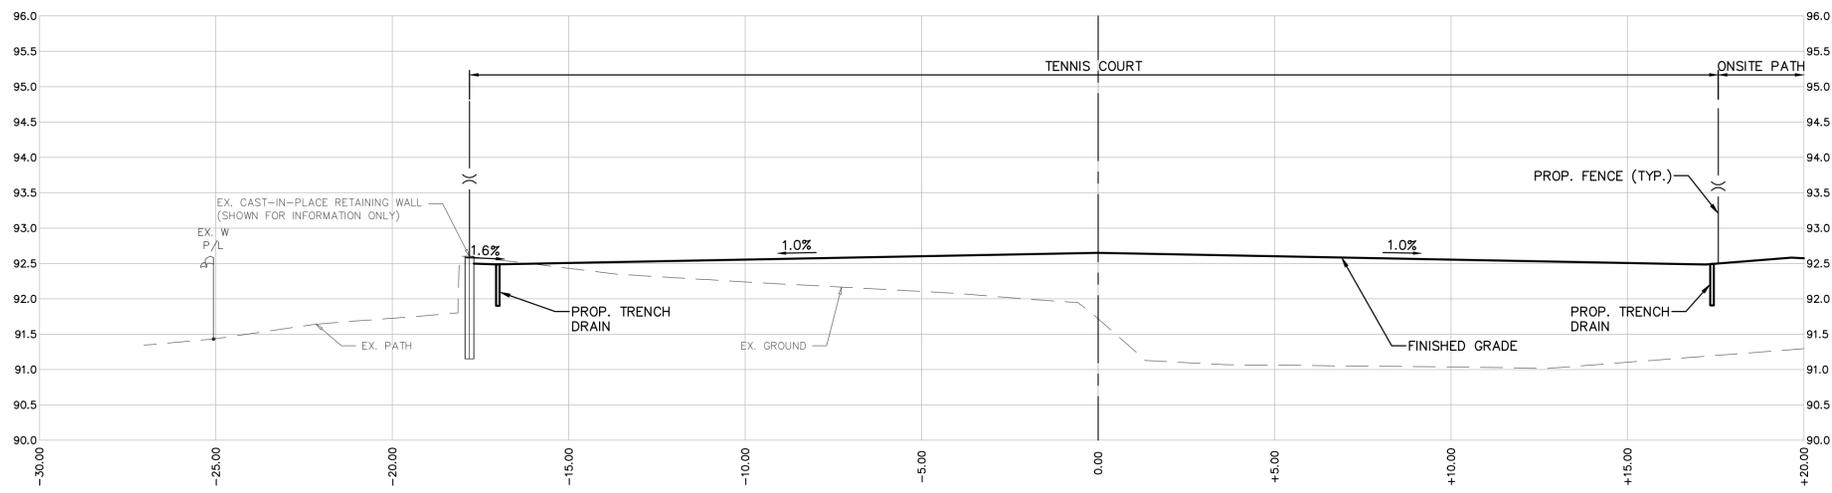
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Coquitlam
Engineering & Public Works
3000 Guildford Way, Coquitlam, B.C. V3B 7N2


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Sheet of **06 of 26**
Eng. Project No. **PROJ 25-015**

Project: **BURKE MOUNTAIN ATHLETIC PARK**
Description: **GRADING PLAN - SOUTH**
File: 18-264A


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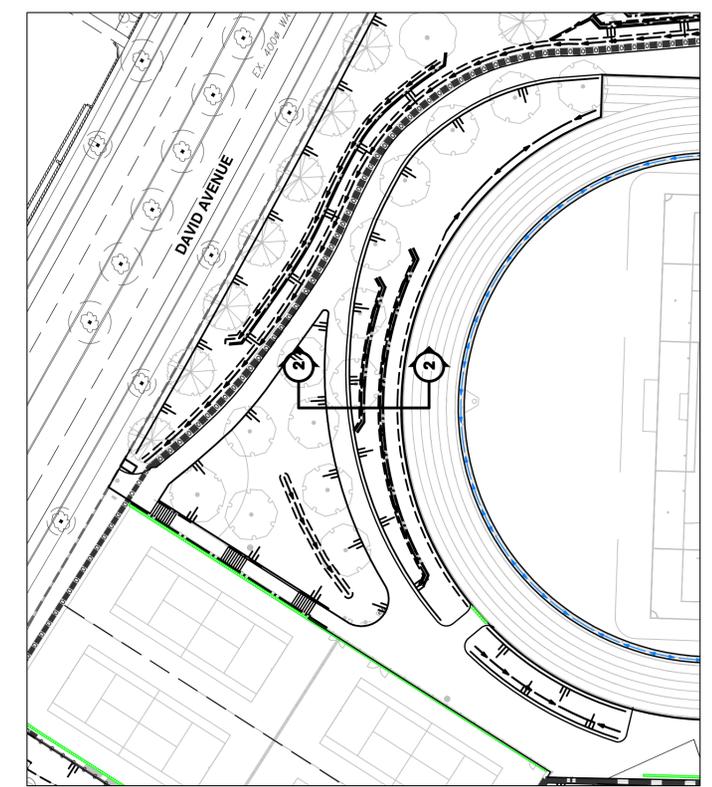
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LOCATION PLAN SECTION 1-1
SCALE: 1:500



SECTION 2-2
SCALE: H - 1:100, V - 1:50

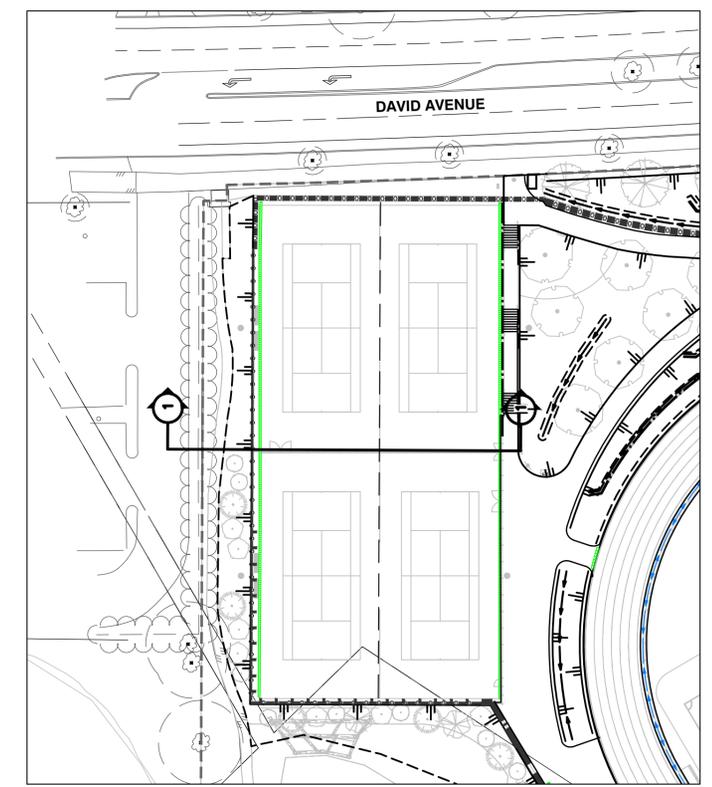

LOCATION PLAN SECTION 2-2
SCALE: 1:500

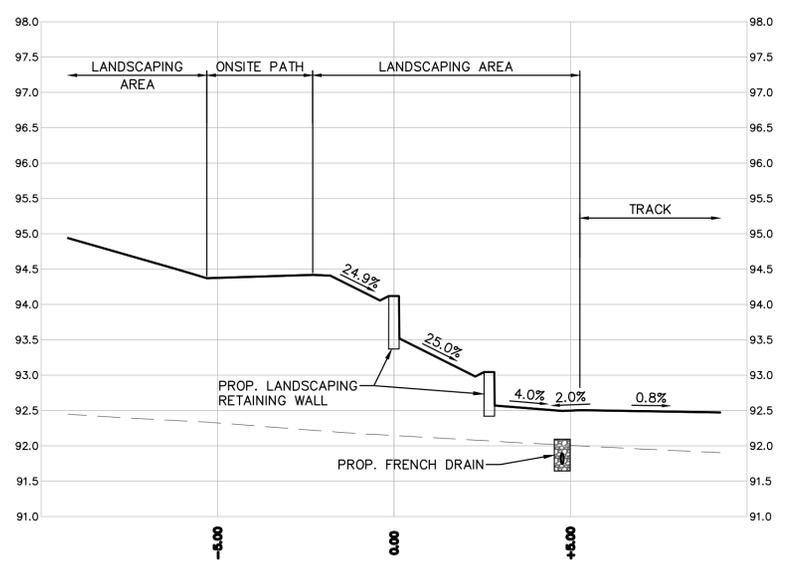Edge of pavement	Hydrant	Sanitary service	Hydro Guy Wire
Watermain and valve	Water air valve	Sanitary cleanout	Hydro Kiosk
Drainage sewer, MH	Water blowoff	Utility pole (joint pole)	Vegetation Conifer
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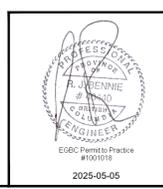
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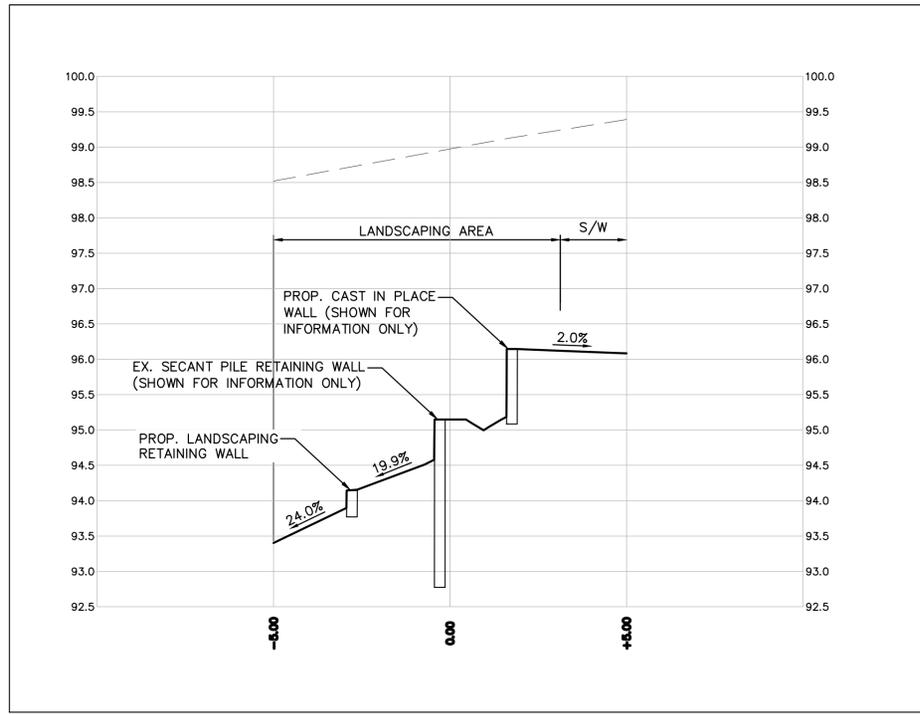
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Sheet of **07 of 26**
Eng. Project No. **PROJ 25-015**


Project **BURKE MOUNTAIN ATHLETIC PARK**
Description **CROSS SECTIONS - TENNIS COURT**
File: 18-264A




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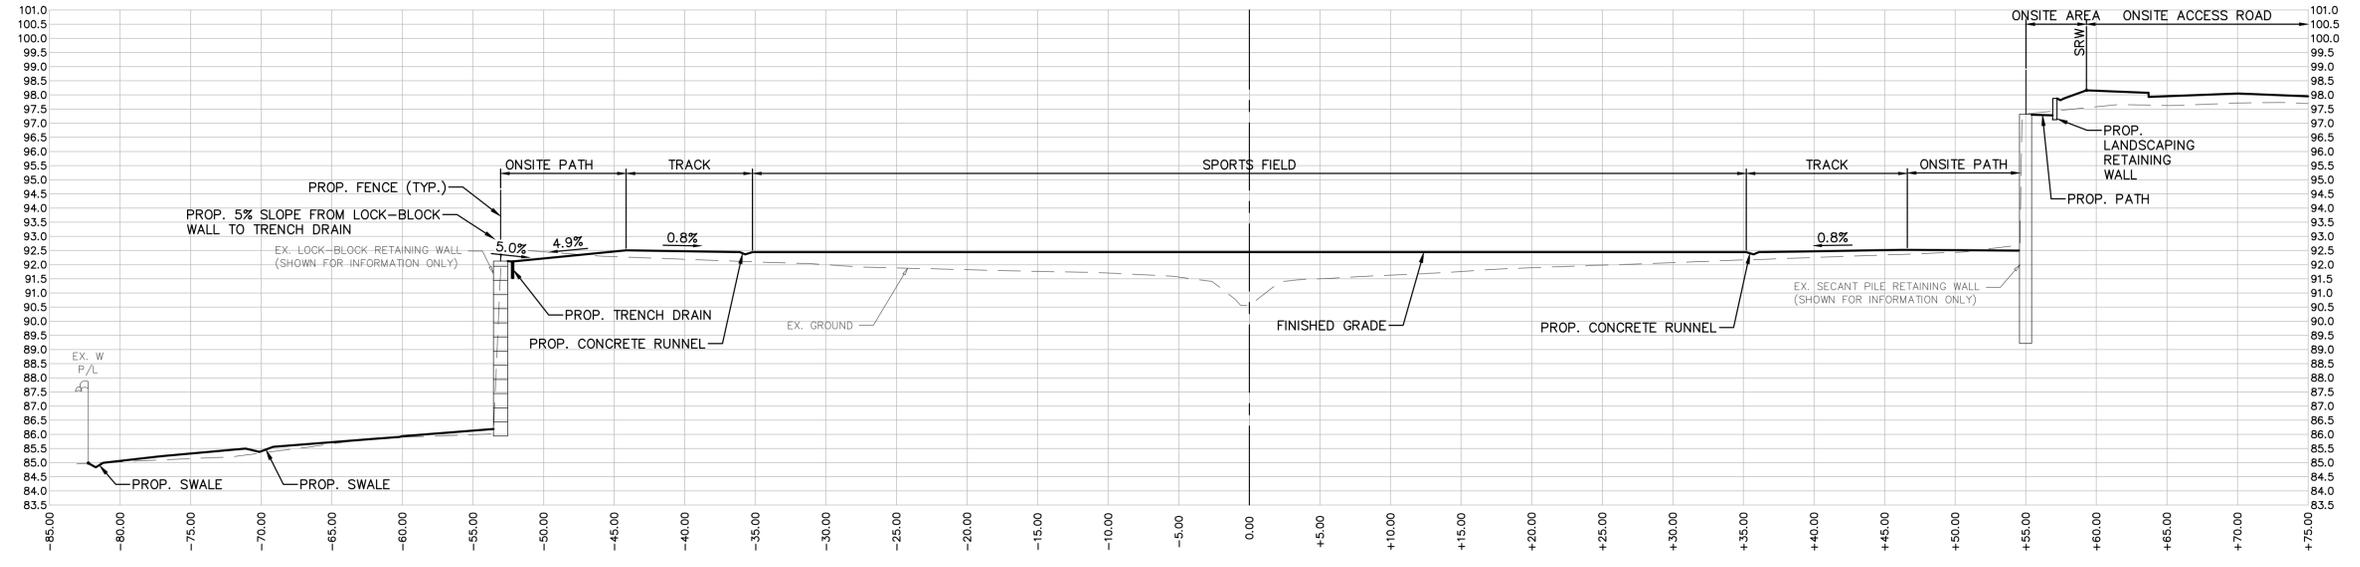
SECTION 4-4
SCALE: H - 1:100, V - 1:50



LOCATION PLAN SECTION 4-4
SCALE: 1:100

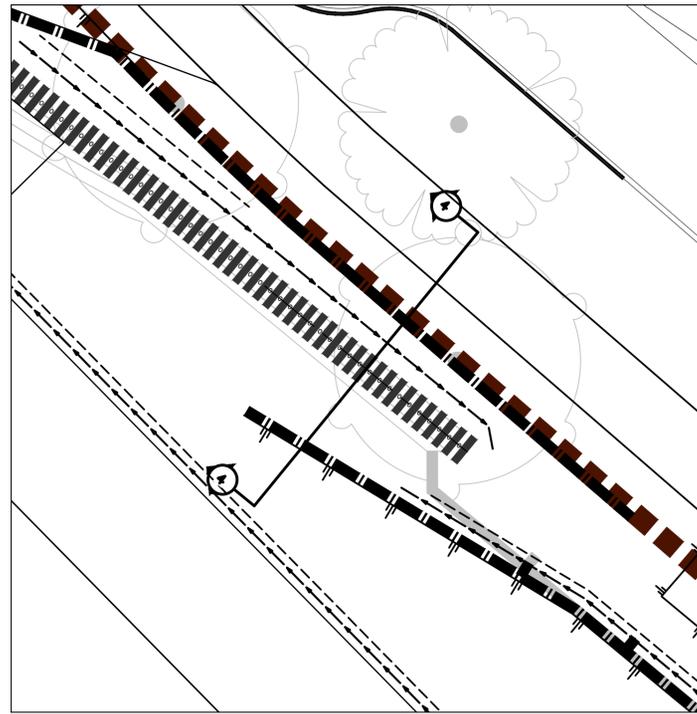

LOCATION PLAN SECTION 3-3
SCALE: 1:1000

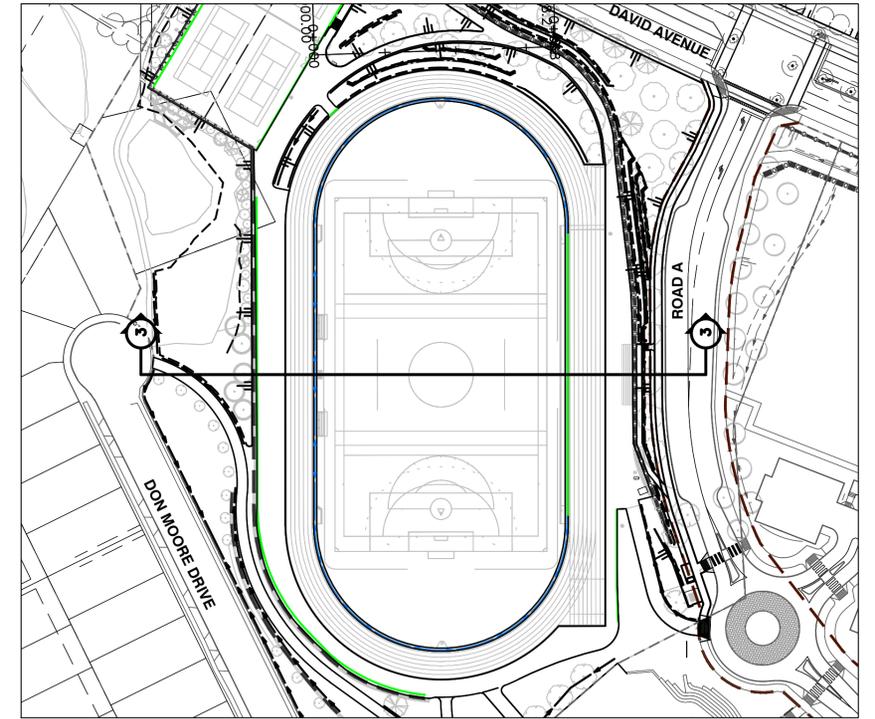

SECTION 3-3
SCALE: H - 1:250, V - 1:125

Edge of pavement	Hydrant	Sanitary service	Hydro Guy Wire
Watermain and valve	Water air valve	Sanitary cleanout	Hydro Kiosk
Drainage sewer, MH	Water blowoff	Utility pole (joint pole)	Vegetation Conifer
Drainage ditch	Water service	Utility pole with light	Vegetation Deciduous
Sanitary sewer, MH	Catch basin, top inlet	Streetlight, dovit	Vegetation Shrub
Sanitary forcemain	Catch basin, side inlet	Streetlight, post top	Survey Traverse Hub
Gasmain and valve	Catch basin, round	Comb signal pole	Survey Iron Pin
Hydro duct, MH	Drainage service	Traffic signal pole	Survey Lead Plug
Telephone duct, MH	Drainage cleanout	Junction box	Survey Monument

No.	Date	By	Revisions
7	2025-05-05	RJB	ISSUED FOR RFP
6	2025-04-24	RJB	REISSUED FOR RFP REVIEW
5	2025-01-17	RJB	ISSUED FOR RFP REVIEW
4	2024-12-16	RJB	ISSUED FOR 100% REVIEW
3	2024-11-28	RJB	ISSUED FOR 85% REVIEW
2	2024-07-10	RJB	ISSUED FOR ALTERNATIVE COSTING
1	2024-05-08	RJB	ISSUED FOR 75% REVIEW

Design by: ASB Date: MAY, 2024
 Drawn by: ASB Date: MAY, 2024
 Checked by: RJB Date: MAY, 2024
 Approved by: RJB Date: MAY, 2024

APLIN MARTIN
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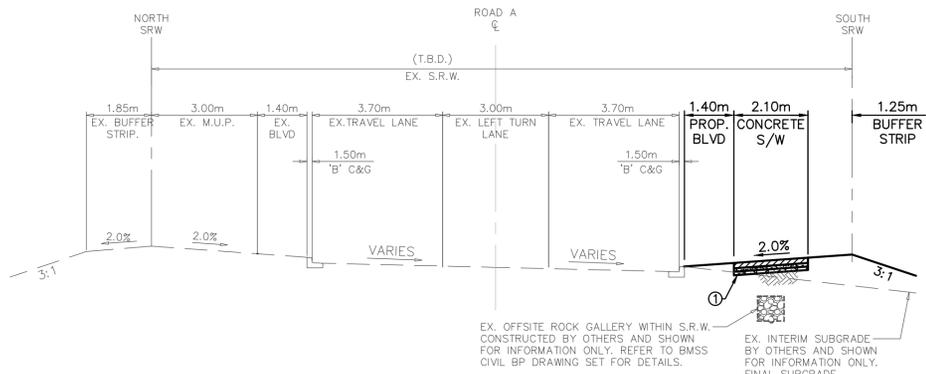
ACCEPTED FOR CONSTRUCTION
 Date: _____
 Manager of Development Servicing

Coquitlam
 Engineering & Public Works
 3000 Guildford Way, Coquitlam, B.C. V3B 7N2


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 Sheet of **08 of 26**
 Eng. Project No. **PROJ 25-015**

BURKE MOUNTAIN ATHLETIC PARK
 Description: **CROSS SECTIONS - SPORTS FIELD**
 File: 18-264A







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STA. 0+007.68 TO 0+060
N.T.S.

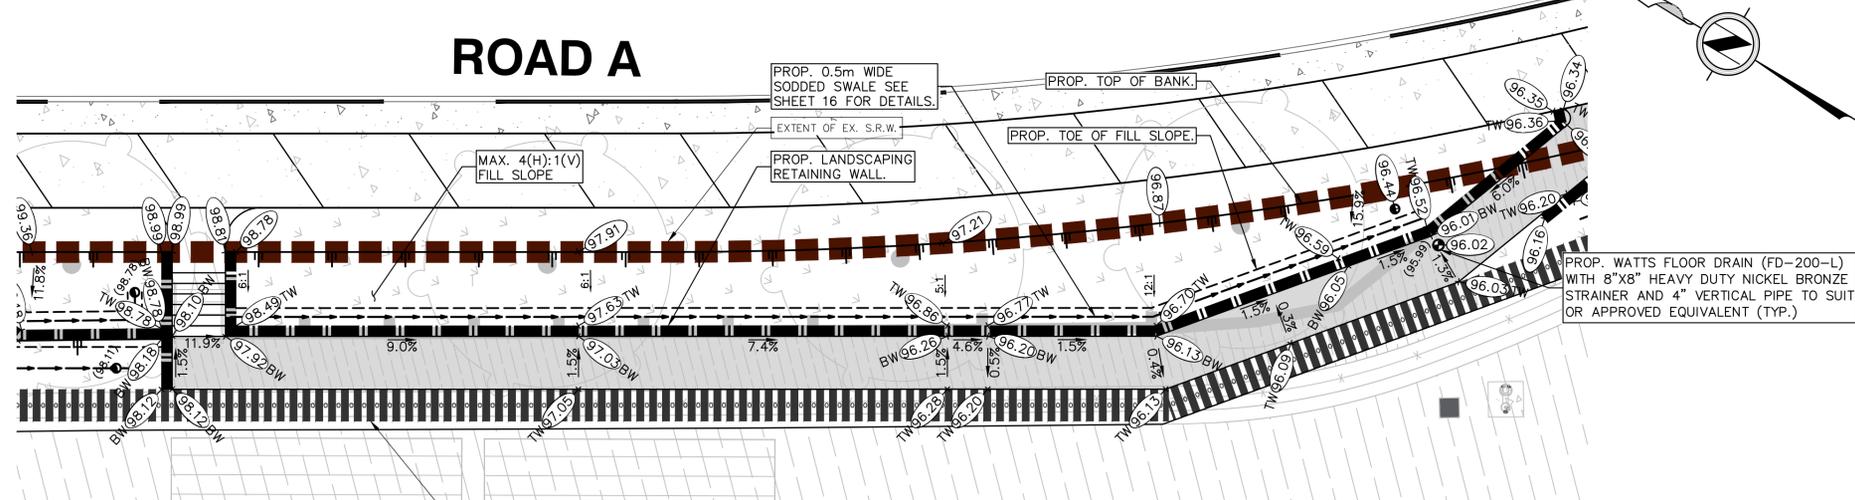


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SCALE = 1:100

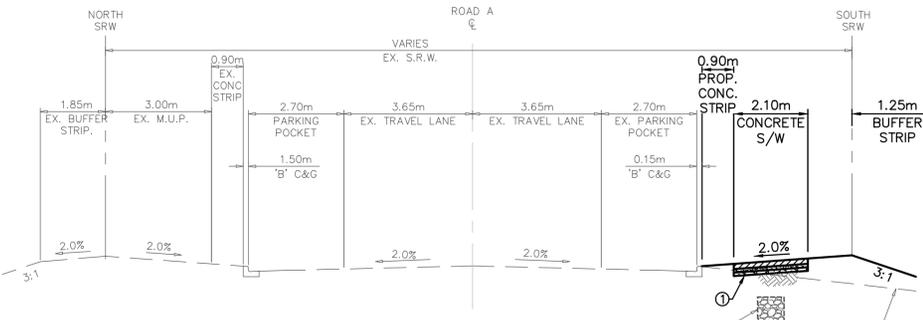

ROAD A TYPICAL CROSS SECTION (S.R.W.)
N.T.S.

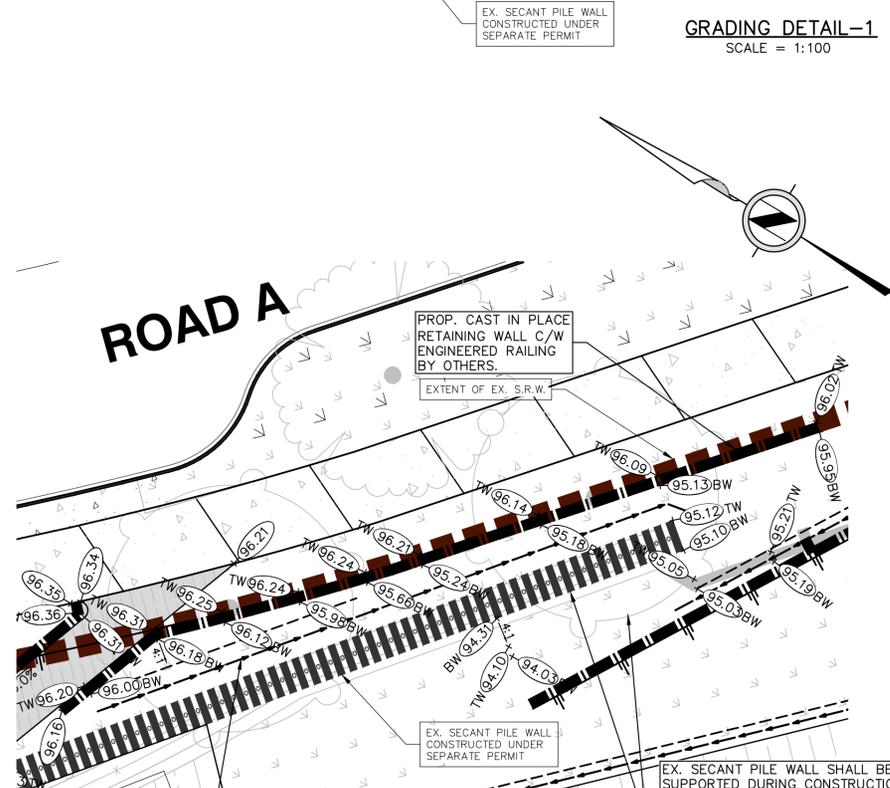

GRADING DETAIL-2
SCALE = 1:100

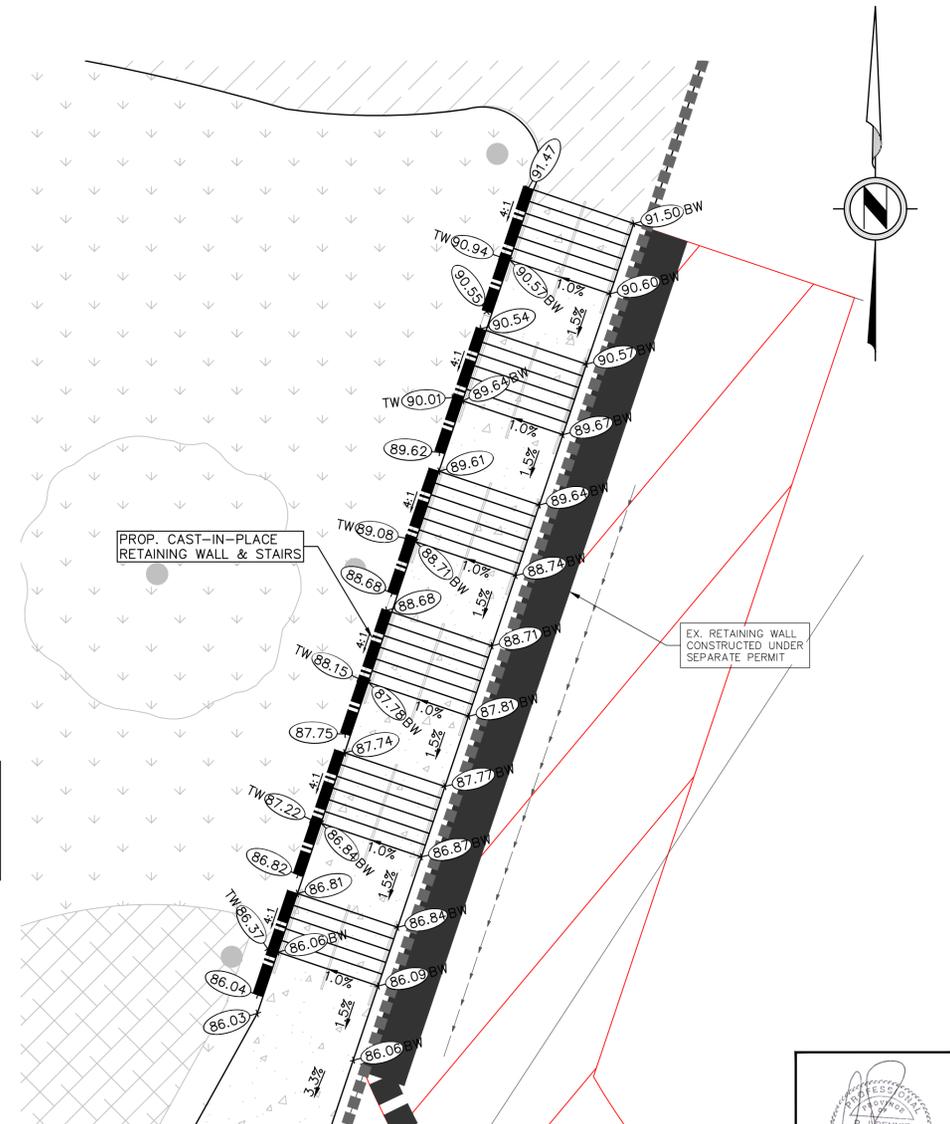

GRADING DETAIL-3
SCALE = 1:100

ROAD STRUCTURE


① 100mm CONCRETE SIDEWALK C/W 100mm - 19mm MINUS CRUSHED GRANULAR BASE COURSE (200mm AT DRIVEWAYS)

NOTE: PAVEMENT TO BE CONSTRUCTED IN ACCORDANCE WITH GEOTECHNICAL REPORT BY THURBER ENGINEERING, DATED 5 MAY, 2023

TYPICAL ONSITE ASPHALT PAVEMENT STRUCTURE
N.T.S.

- ① 35mm - ASPHALT SURFACE COURSE
- ② 40mm - ASPHALT BASE COURSE
- ③ 200mm - 19mm MINUS CRUSHED GRANULAR BASE COURSE COMPACTED TO MIN. 95% MPMD
- ④ 300mm - 75mm MINUS SELECT GRANULAR SUB-BASE COURSE COMPACTED TO MIN. 95% MPMD
- ⑤ SUBGRADE: EITHER VERY DENSE GLACIAL TILL-LIKE SOIL OR ADEQUATELY PLACED AND COMPACTED BACKFILL SOILS (IMPORTED STRUCTURAL FILL OR GLACIAL TILL-LIKE FILL). GEOTECHNICAL ENGINEER TO APPROVE SUBGRADE PRIOR TO GRANULAR SUB-BASE PLACEMENT.

NOTE: PAVEMENT TO BE CONSTRUCTED IN ACCORDANCE WITH GEOTECHNICAL REPORT BY THURBER ENGINEERING, DATED JANUARY 17, 2025.

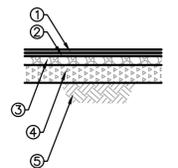

Edge of pavement	Hydrant	Sanitary service	Hydro Guy Wire
Watermain and valve	Water air valve	Sanitary cleanout	Hydro Kiosk
Drainage sewer, MH	Water blowoff	Utility pole (joint pole)	Vegetation Conifer
Drainage ditch	Water service	Utility pole with light	Vegetation Deciduous
Sanitary sewer, MH	Catch basin, top inlet	Streetlight, dov't	Vegetation Shrub
Sanitary forcemain	Catch basin, side inlet	Streetlight, post top	Survey Traverse Hub
Gasmain and valve	Catch basin, round	Comb signal pole	Survey Iron Pin
Hydro duct, MH	Drainage service	Traffic signal pole	Survey Lead Plug
Telephone duct, MH	Drainage cleanout	Junction box	Survey Monument

No.	Date	By	Revisions
7	2025-05-05	RJB	ISSUED FOR RFP
6	2025-04-24	RJB	REISSUED FOR RFP REVIEW
5	2025-01-17	RJB	ISSUED FOR RFP REVIEW
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3	2024-11-28	RJB	ISSUED FOR 85% REVIEW
2	2024-07-10	RJB	ISSUED FOR ALTERNATIVE COSTING
1	2024-05-08	RJB	ISSUED FOR 75% REVIEW

Design by: **APLIN MARTIN**
Date: MAY, 2024

Drawn by: **ASB**
Date: MAY, 2024

Checked by: **RJB**
Date: MAY, 2024

Approved by: **RJB**
Date: MAY, 2024

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Email: general@aplinmartin.com


ACCEPTED FOR CONSTRUCTION
Date: _____
Manager of Development Servicing

Coquitlam
Engineering & Public Works
3000 Guildford Way, Coquitlam, B.C. V3B 7N2


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Sheet of **09 of 26**
Eng. Project No. **PROJ 25-015**

Project: **BURKE MOUNTAIN ATHLETIC PARK**
Description: **GRADING - DETAILS**
File: 18-264A

MAY 05 2025 11:47am M:\SUR-LD\2018\18-2644\DWG\ONSITE - PRODUCTION\18-2644 - GRADING DETAILS.dwg/10 GRADING - DETAILS - 2 fhsu

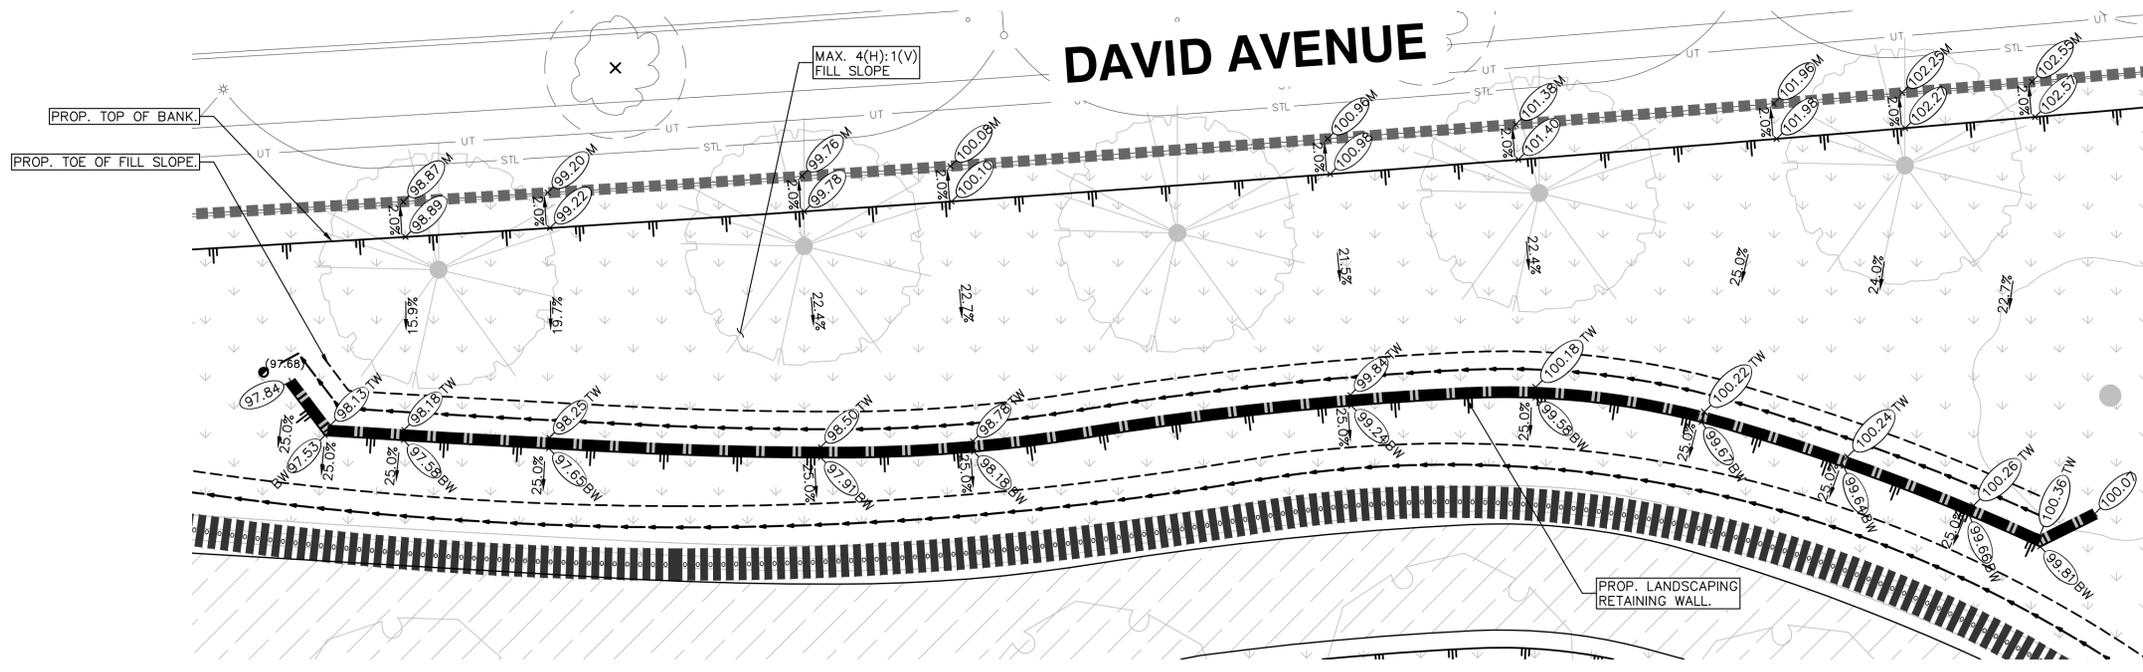

GRADING DETAIL-4
SCALE = 1:100

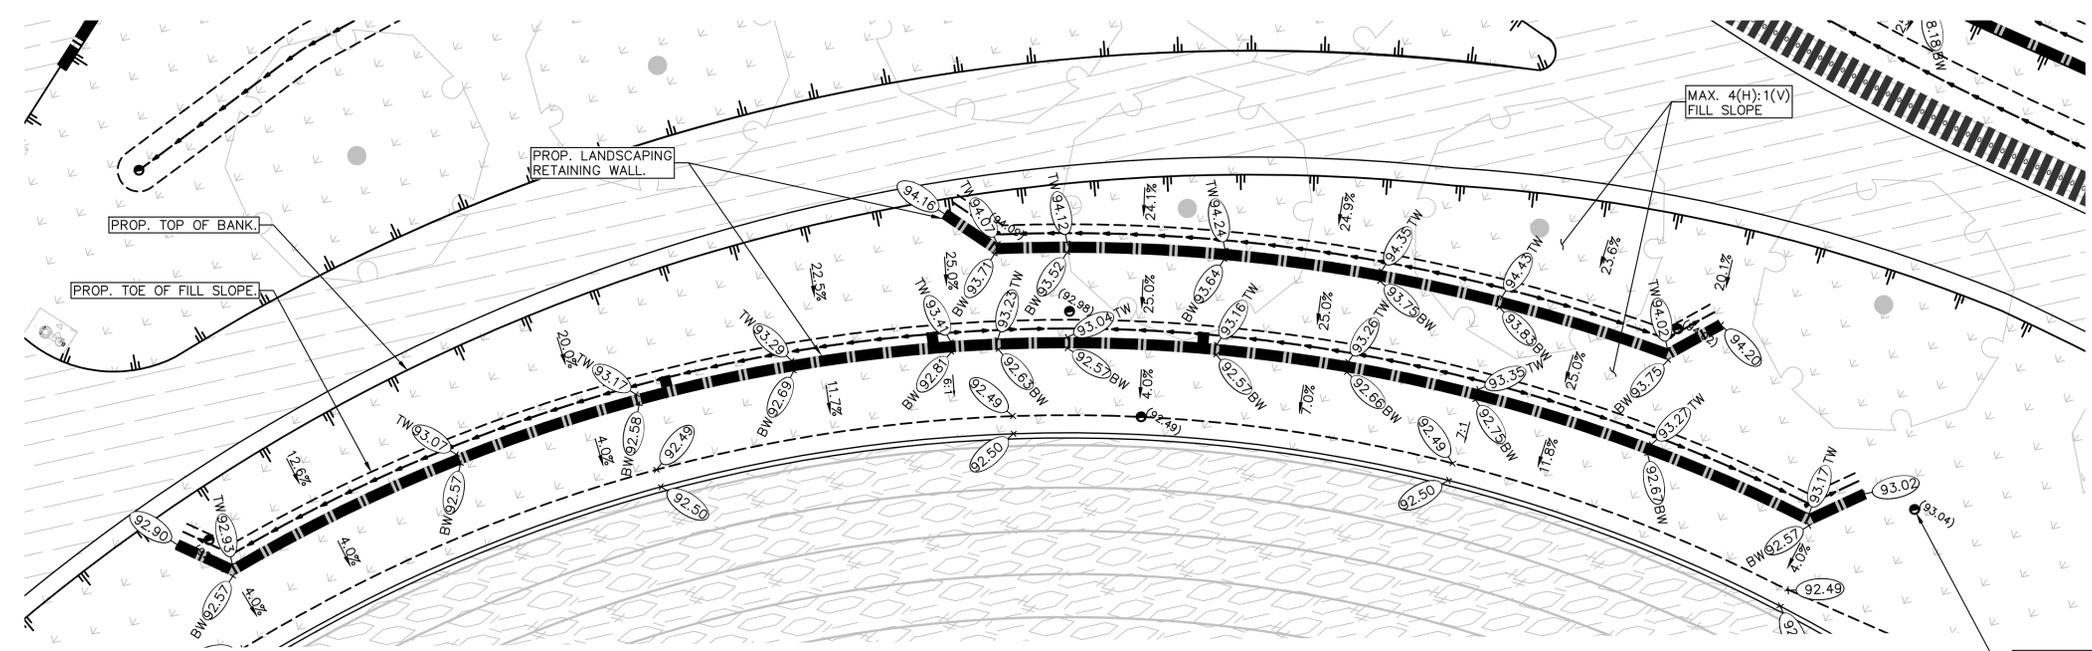

GRADING DETAIL-5
SCALE = 1:100

Edge of pavement	Hydrant	Sanitary service	Hydro Guy Wire
Watermain and valve	Water air valve	Sanitary cleanout	Hydro Kiosk
Drainage sewer, MH	Water blowoff	Utility pole (joint pole)	Vegetation Conifer
Drainage ditch	Water service	Utility pole with light	Vegetation Deciduous
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2	2024-07-10	RJB	ISSUED FOR ALTERNATIVE COSTING
1	2024-05-08	RJB	ISSUED FOR 75% REVIEW

Design by: **ASB** Date: **MAY, 2024**

Drawn by: **ASB** Date: **MAY, 2024**

Checked by: **RJB** Date: **MAY, 2024**

Approved by: **RJB** Date: **MAY, 2024**

EGBC Permit to Practice Number #1001918
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Tel: (604) 597-9058, Fax: (604) 597-9061
Email: general@aplinmartin.com

ACCEPTED FOR CONSTRUCTION

Date: _____

Manager of Development Servicing

Engineering & Public Works


3000 Guildford Way, Coquitlam, B.C. V3B 7N2

Scale horiz.	N/A	Scale vert.	N/A
Sheet of	10 of 26		
Eng. Project No.	PROJ 25-015		

Project: **BURKE MOUNTAIN ATHLETIC PARK**

Description: **GRADING - DETAILS - 2**

File: 18-2644

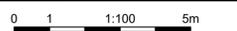

GENERAL NOTES:


1. PROPOSED SITE LAYOUT ARE AS PER SITE PLANS DATED JANUARY 15, 2025 BY VDZ+A.
2. EXISTING LEGAL LOT LINES HAVE BEEN OBTAINED FROM TOPOGRAPHIC SURVEY BY TARGET LAND SURVEYING, DATED FEBRUARY 13, 2024.

STRIPPING NOTES:

1. STRIPPING DEPTH DERIVED FROM EXISTING GROUND SURFACE, AS SPECIFIED IN TOPOGRAPHIC SURVEY.

EARTHWORK NOTES:

1. EXISTING GROUND ELEVATIONS HAVE BEEN OBTAINED FROM DRONE SURVEY DATED NOVEMBER 25, 2024.
2. PROPOSED SURFACE HAS BEEN DEVELOPED FROM EXISTING SURFACE TO ESTABLISH FINISHED GRADES USING CUT AND FILL, EXCLUDING SOIL STRIPPING OUTSIDE OF GEOTECHNICAL EXPLORATION SCOPE.
3. ALL EXCAVATION, FILL PLACEMENT AND COMPACTION TO BE IN ACCORDANCE WITH GEOTECHNICAL CONSULTANT'S REPORT.

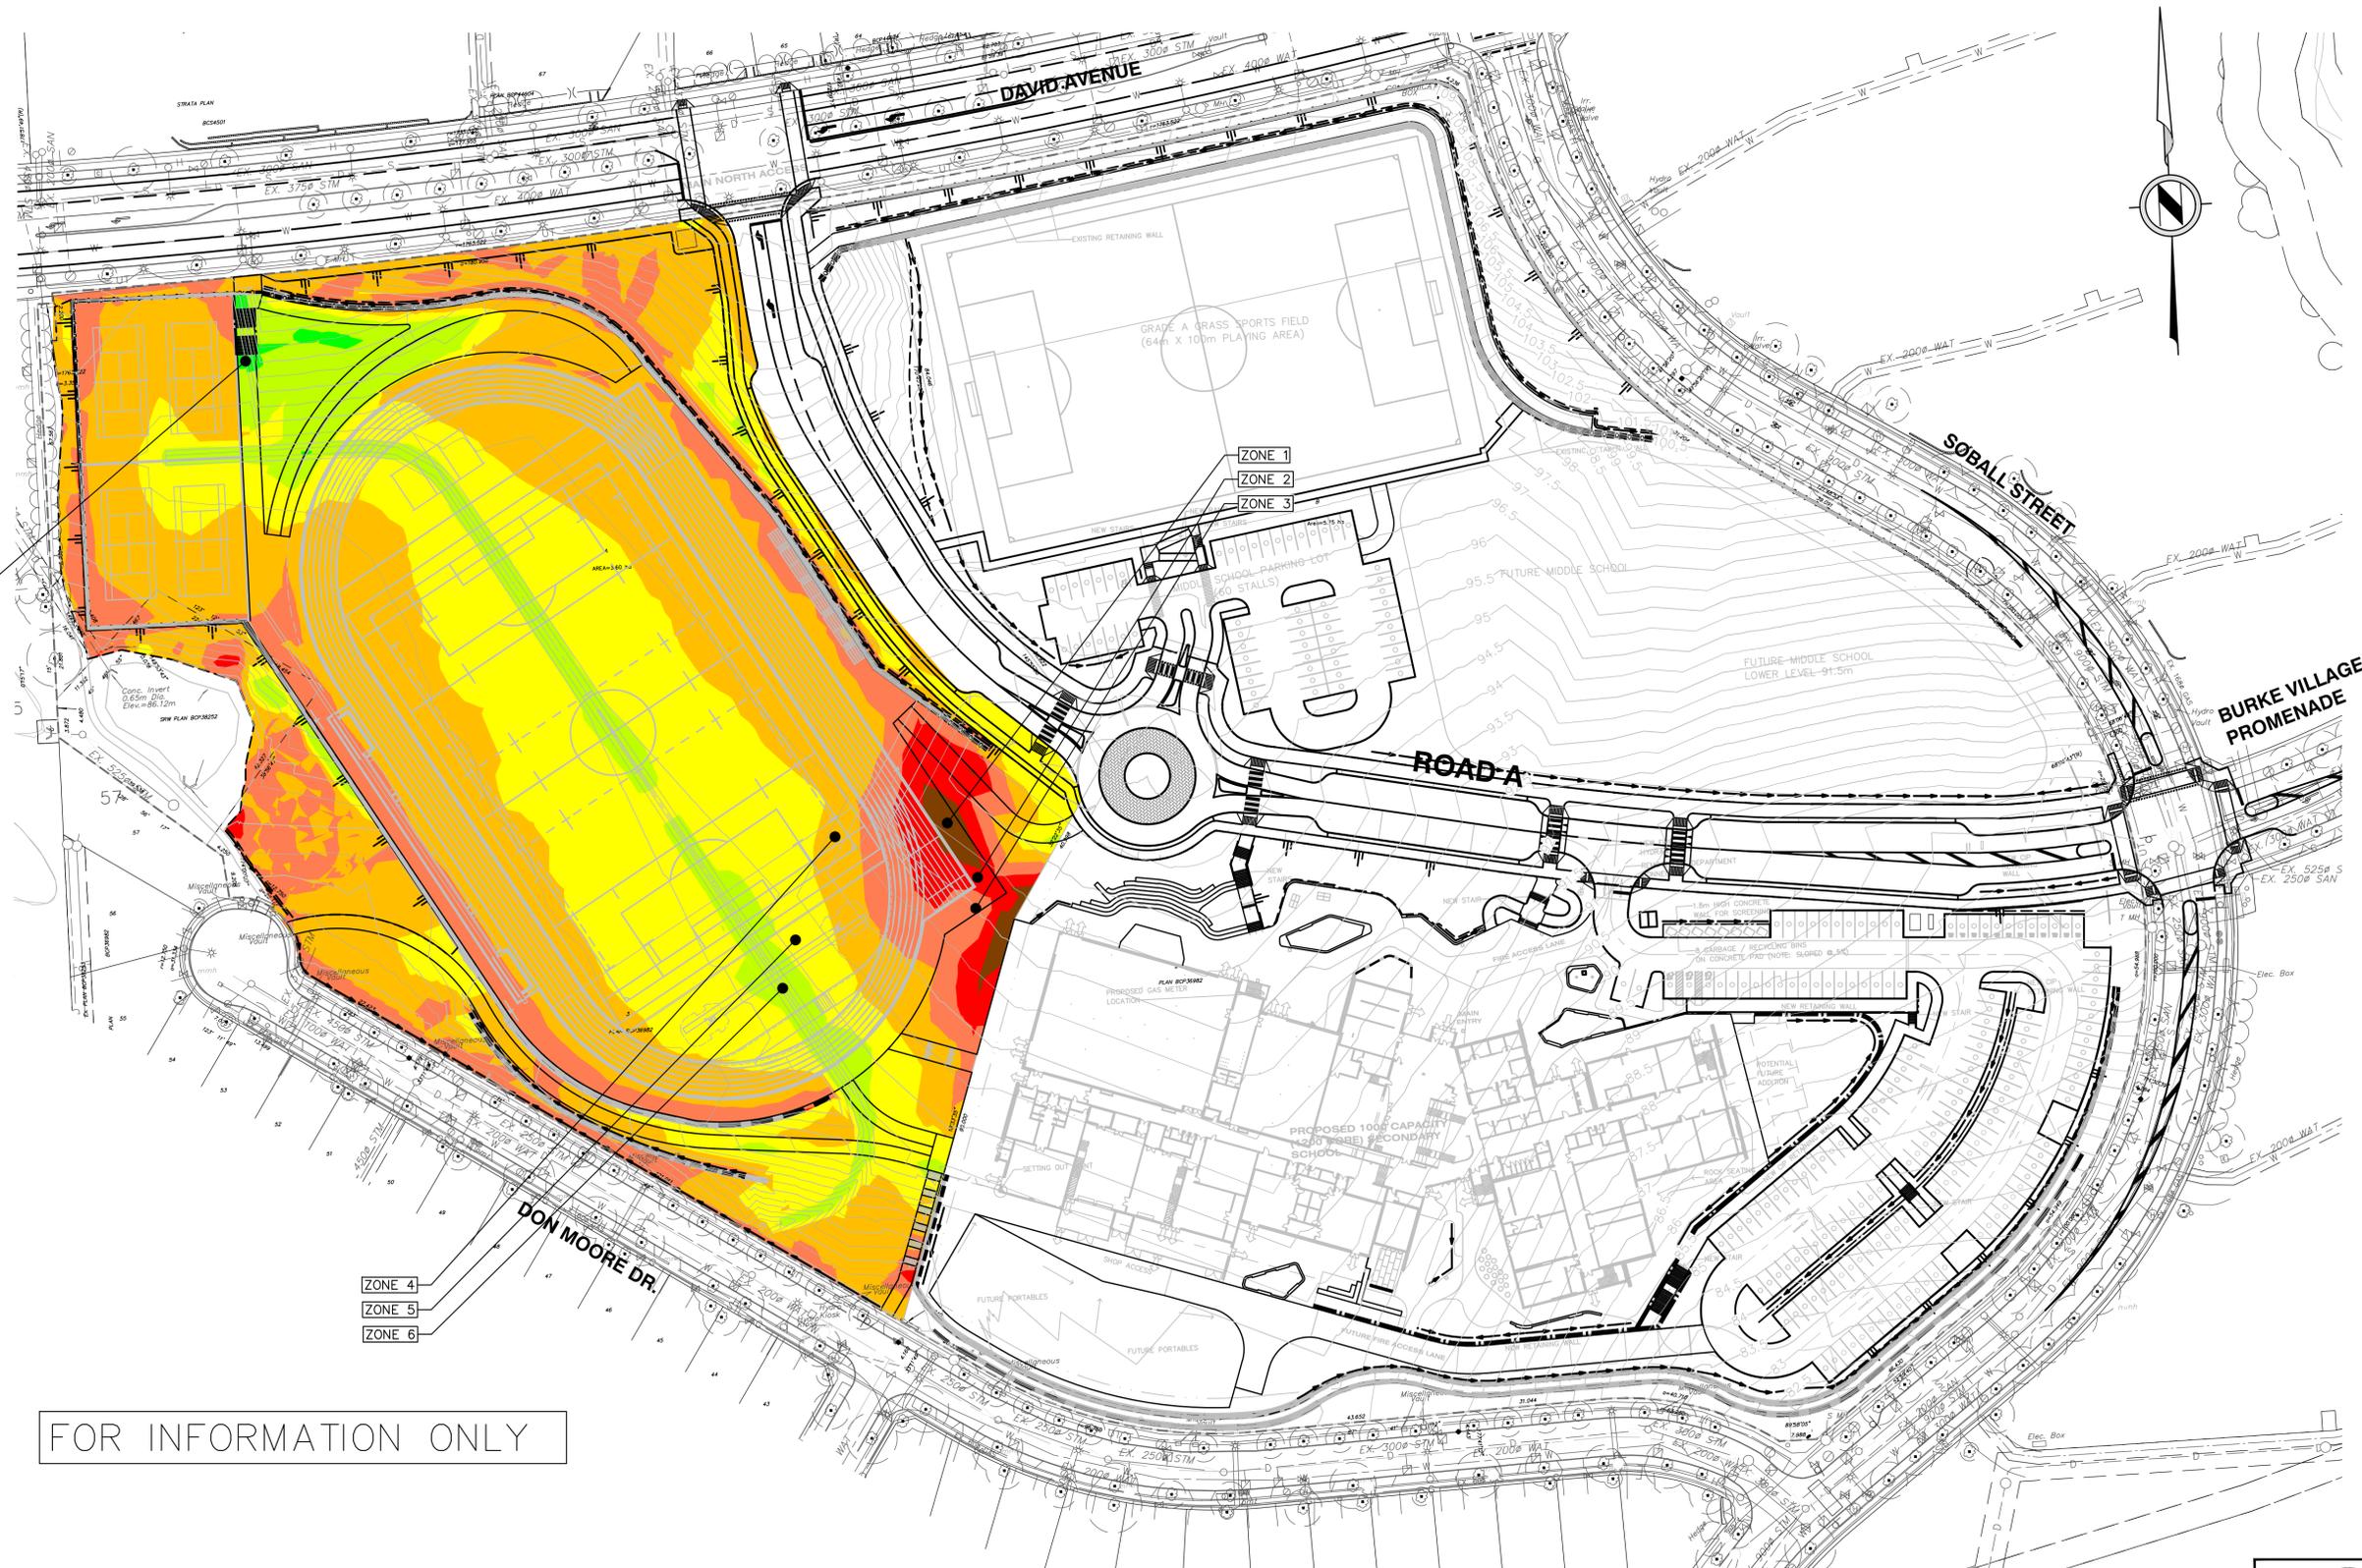

ZONE NO.	COLOUR	CUT-FILL DEPTH (m)
1		-2.50 ~ -1.00
2		-1.00 ~ -0.50
3		-0.50 ~ 0.00
4		0.00 ~ 0.50
5		0.50 ~ 1.00
6		1.00 ~ 2.50
7		2.50 ~ 5.00

FOR INFORMATION ONLY

NOTE: THESE DRAWINGS ARE TO BE READ IN CONJUNCTION WITH THE CURRENT LANDSCAPE, MECHANICAL, ARCHITECTURAL, ELECTRICAL, STREETLIGHTING, GEOTECHNICAL & STRUCTURAL DRAWINGS.

NOTE: CUT/FILL DEPTHS SHOWN IN THIS PLAN ARE APPROXIMATE AND PROVIDED FOR INFORMATION ONLY.

Edge of pavement	Hydrant	Sanitary service	Hydro Guy Wire
Watermain and valve	Water air valve	Sanitary cleanout	Hydro Kiosk
Drainage sewer, MH	Water blowoff	Utility pole (joint pole)	Vegetation Conifer
Drainage ditch	Water service	Utility pole with light	Vegetation Deciduous
Sanitary sewer, MH	Catch basin, top inlet	Streetlight, down	Vegetation Shrub
Sanitary forcemain	Catch basin, side inlet	Streetlight, post top	Survey Traverse Hub
Gasmain and valve	Catch basin, round	Comb signal pole	Survey Iron Pin
Hydro duct, MH	Drainage service	Traffic signal pole	Survey Lead Plug
Telephone duct, MH	Drainage cleanout	Junction box	Survey Monument

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3	2024-11-28	RJB	ISSUED FOR 85% REVIEW
2	2024-07-10	RJB	ISSUED FOR ALTERNATIVE COSTING
1	2024-05-08	RJB	ISSUED FOR 75% REVIEW

Design by: ASB Date: MAY, 2024
 Drawn by: ASB Date: MAY, 2024
 Checked by: RJB Date: MAY, 2024
 Approved by: RJB Date: MAY, 2024

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 Tel: (604) 597-9058, Fax: (604) 597-9061
 Email: general@aplinmartin.com

ACCEPTED FOR CONSTRUCTION
 Date: _____
 Manager of Development Servicing

Coquitlam
 Engineering & Public Works
 3000 Guildford Way, Coquitlam, B.C. V3B 7N2


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 Sheet of: 12 of 26
 Eng. Project No. PROJ 25-015

Project: **BURKE MOUNTAIN ATHLETIC PARK**
 Description: **SITE CUT & FILL ANALYSIS PLAN**
 File: 18-264A

DAVID AVENUE

LEGEND

- STORM SEWER
- CB MANHOLE
- MANHOLE
- CLEANOUT
- CATCH BASIN C/W ALUMINUM TRAPPING HOOD (AS PER MMCD)
- 200# NYLOPLAST RUNNEL CATCH BASIN C/W DUCTILE IRON GRATE
- SODDED SWALE
- STORM SERVICE
- CONTRIBUTING HYDRAULIC LOAD (L)
- AVAILABLE PIPE CAPACITY (L)
- PROP. RUNNEL
- PROP. TRENCH DRAIN

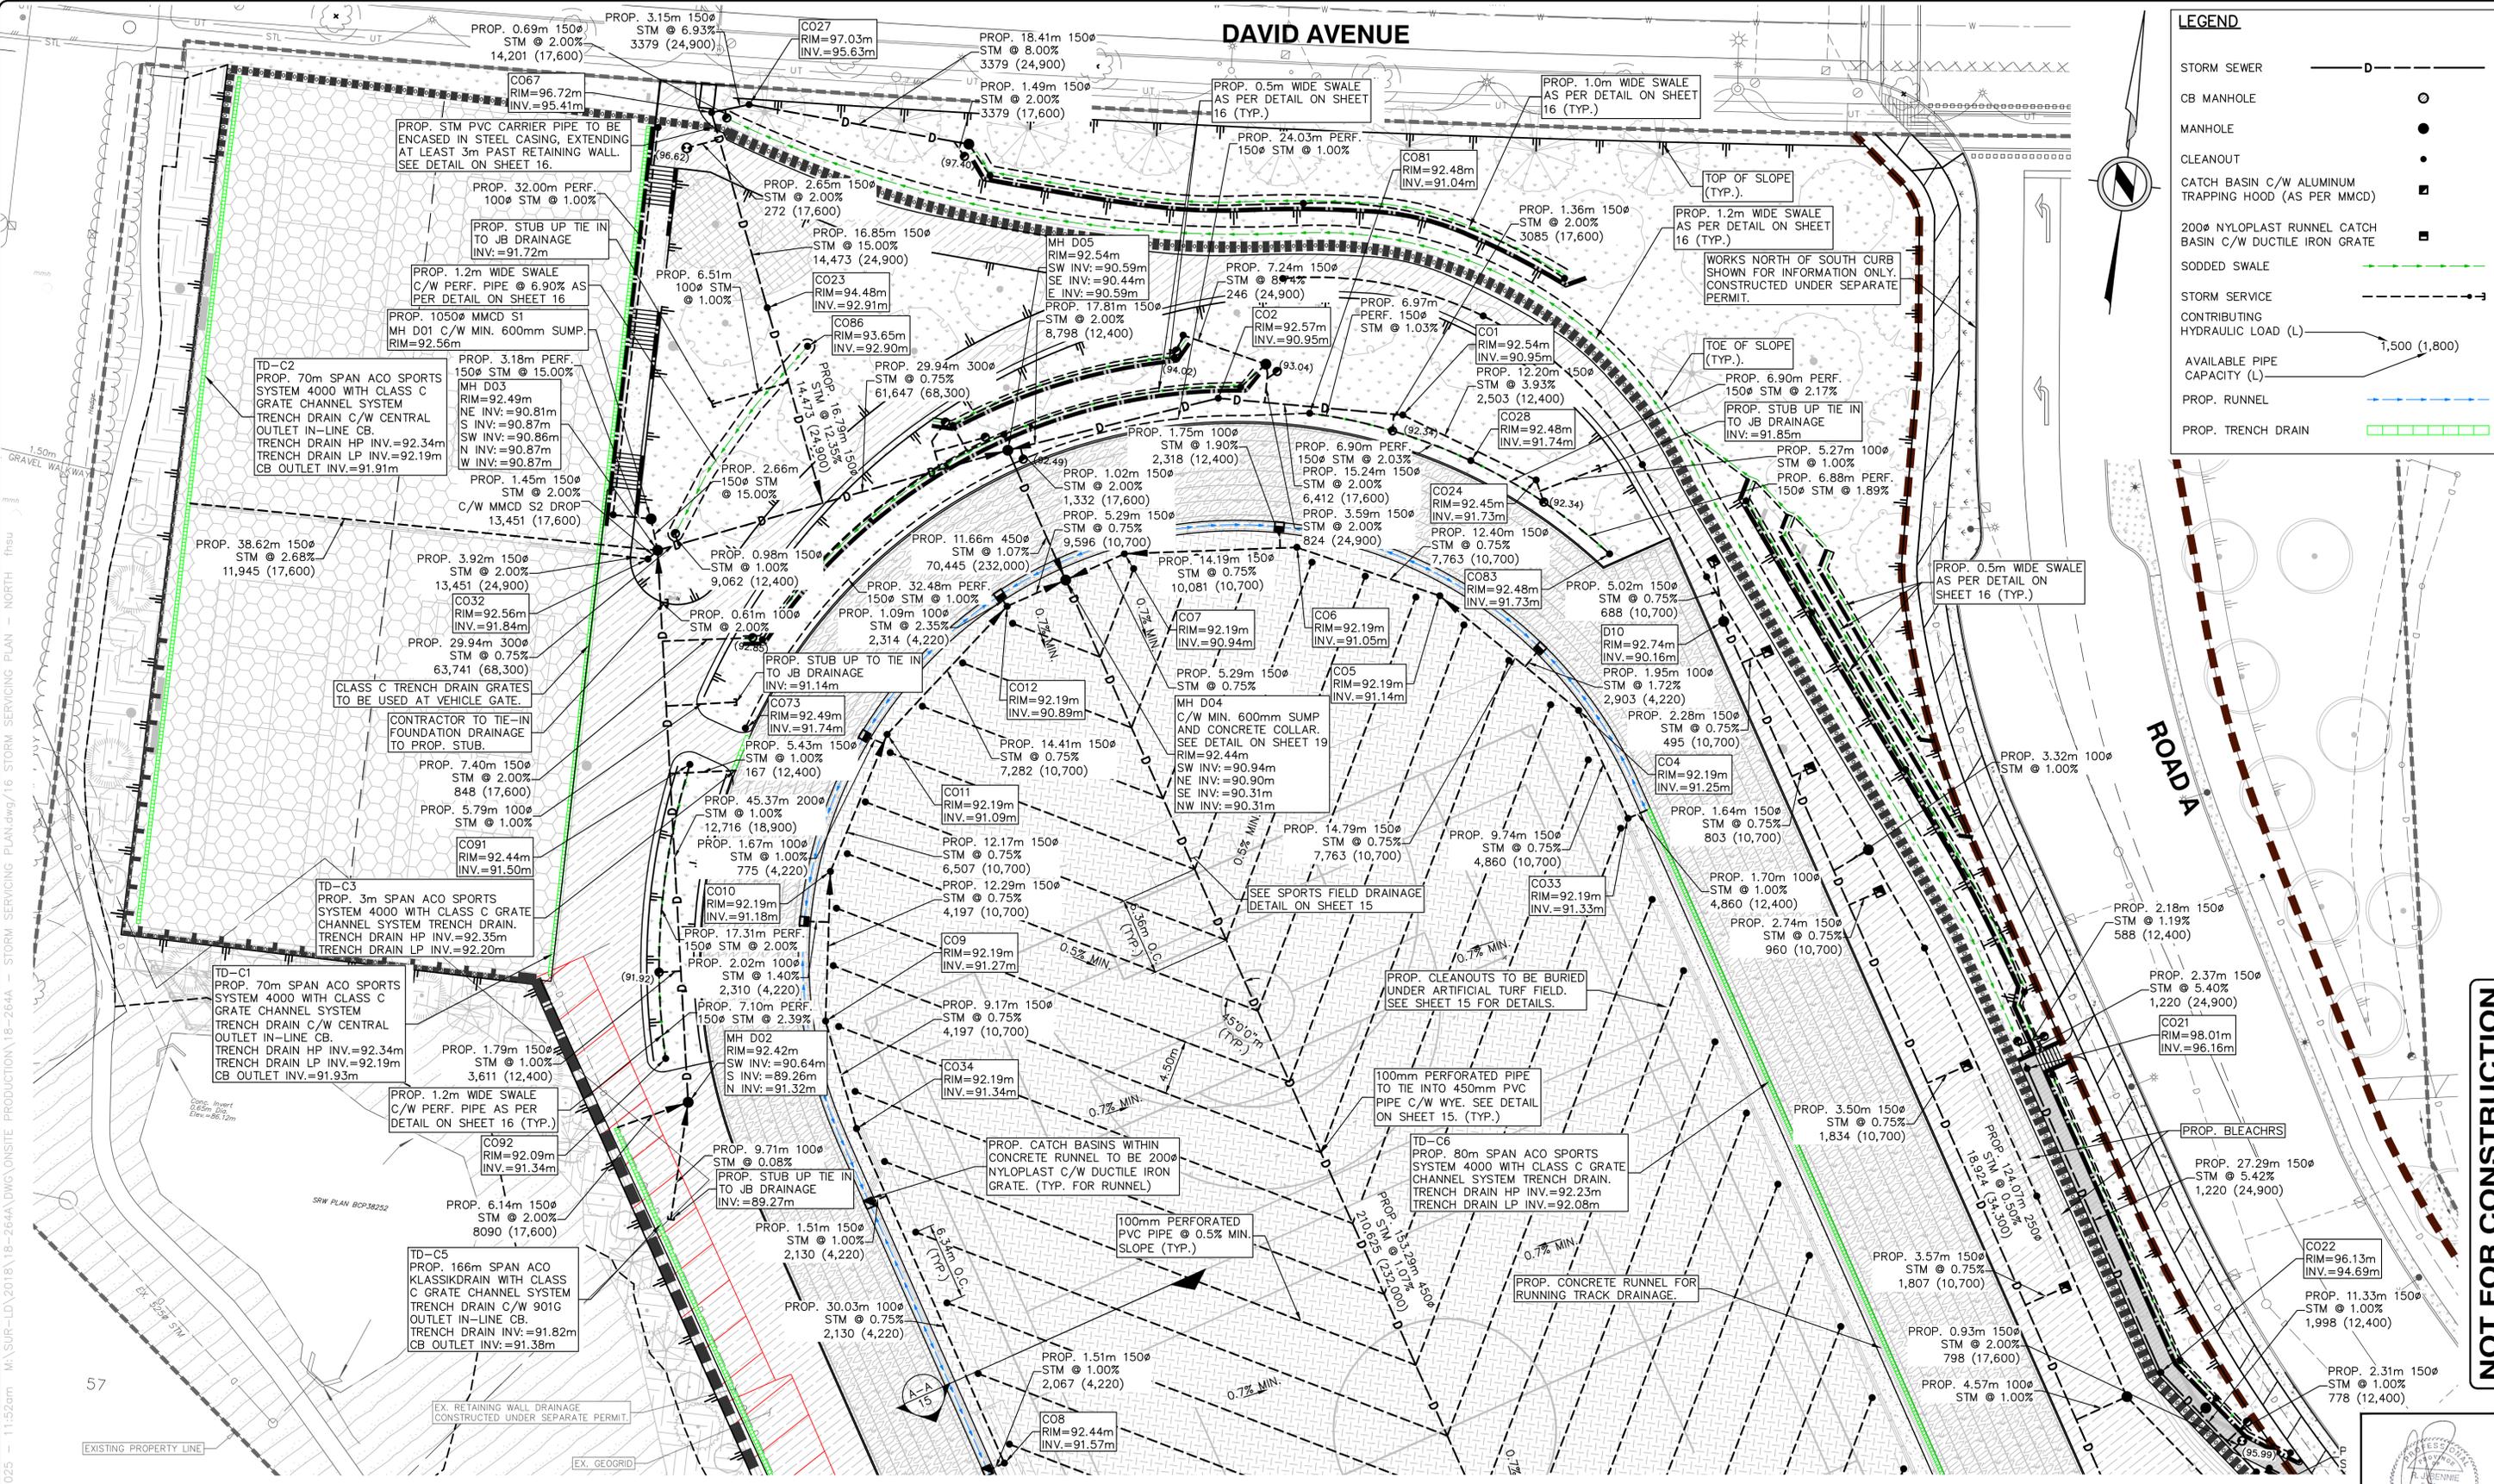

NOTE: THESE DRAWINGS ARE TO BE READ IN CONJUNCTION WITH THE CURRENT LANDSCAPE, ARCHITECTURAL, ELECTRICAL, STREETLIGHTING, GEOTECHNICAL & STRUCTURAL DRAWINGS.

NOTE: THE CONTRACTOR SHALL REQUEST APPROVAL FROM THE GEOTECHNICAL ENGINEER BEFORE EXCAVATING WITHIN THE GEOGRID ZONE BEHIND THE LOCK BLOCK WALLS. REVIEW DURING EXCAVATION MAY BE REQUIRED BY A REPRESENTATIVE FROM THE GEOTECHNICAL CONSULTANT.

NOTE: ALL CATCH BASINS, EXCEPT ALONG RUNNEL, TO HAVE FRAME & GRATE AS PER DETAIL ON SHEET 16 OF 26.

Edge of pavement	Hydrant	Sanitary service	Hydro Guy Wire
Watermain and valve	Water air valve	Sanitary cleanout	Hydro Kiosk
Drainage sewer, MH	Water blowoff	Utility pole (joint pole)	Vegetation Conifer
Drainage ditch	Water service	Utility pole with light	Vegetation Deciduous
Sanitary sewer, MH	Catch basin, top inlet	Streetlight, down	Vegetation Shrub
Sanitary forcemain	Catch basin, side inlet	Streetlight, post top	Survey Traverse Hub
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Hydro duct, MH	Drainage service	Traffic signal pole	Survey Lead Plug
Telephone duct, MH	Drainage cleanout	Junction box	Survey Monument

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2	2024-07-10	RJB	ISSUED FOR ALTERNATIVE COSTING
1	2024-05-08	RJB	ISSUED FOR 75% REVIEW

Design by: ASB Date: MAY, 2024
 Drawn by: ASB Date: MAY, 2024
 Checked by: RJB Date: MAY, 2024
 Approved by: RJB Date: MAY, 2024

APLIN MARTIN
 201 - 2448 82 Avenue, Surrey, B.C. V3R 5E3
 Tel: (604) 597-0058, Fax: (604) 597-0061
 Email: general@aplinmartin.com

ACCEPTED FOR CONSTRUCTION
 Date: _____
 Manager of Development Servicing


Coquitlam
 Engineering & Public Works
 3000 Guildford Way, Coquitlam, B.C. V3B 7N2

Scale horz. 1:250 Scale vert. N/A
 Sheet of **13 of 26**
 Eng. Project No. **PROJ 25-015**

Project: **BURKE MOUNTAIN ATHLETIC PARK**
 Description: **STORM SERVICING PLAN - NORTH**
 File: 18-264A


NOT FOR CONSTRUCTION



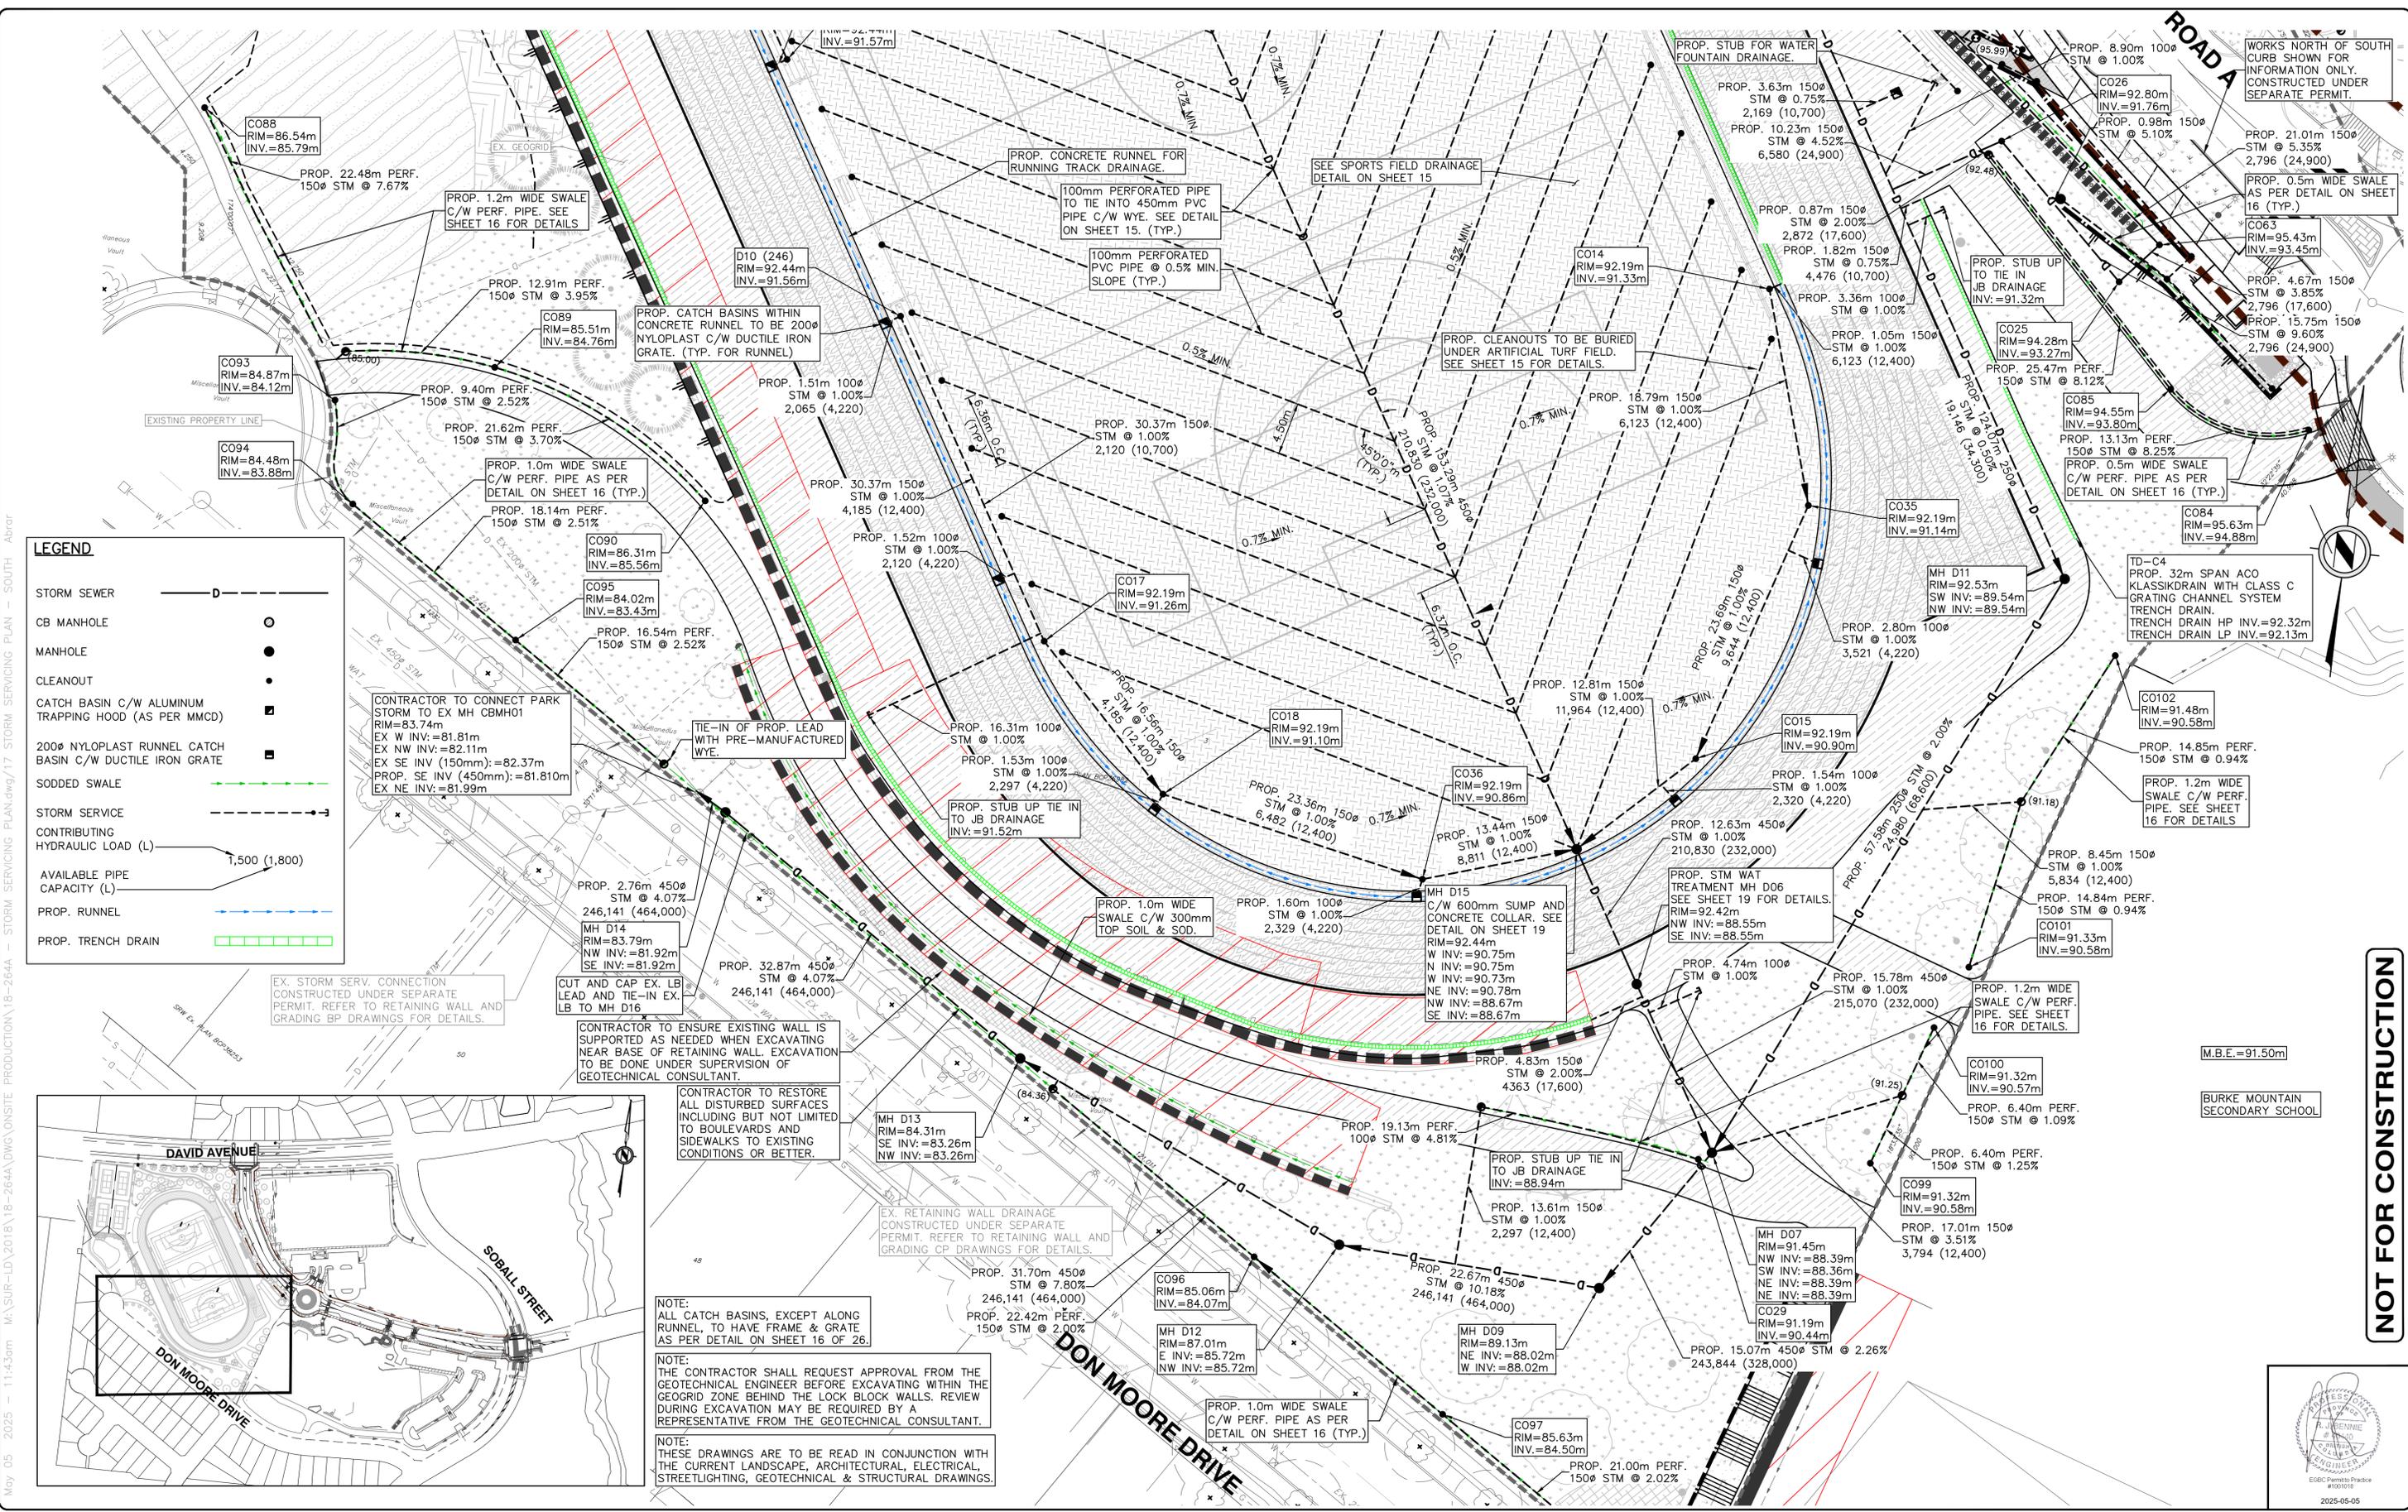

LEGEND

- STORM SEWER
- CB MANHOLE
- MANHOLE
- CLEANOUT
- CATCH BASIN C/W ALUMINUM TRAPPING HOOD (AS PER MMCD)
- 200Ø NYLOPLAST RUNNEL CATCH BASIN C/W DUCTILE IRON GRATE
- SODDED SWALE
- STORM SERVICE
- CONTRIBUTING HYDRAULIC LOAD (L)
- AVAILABLE PIPE CAPACITY (L)
- PROP. RUNNEL
- PROP. TRENCH DRAIN

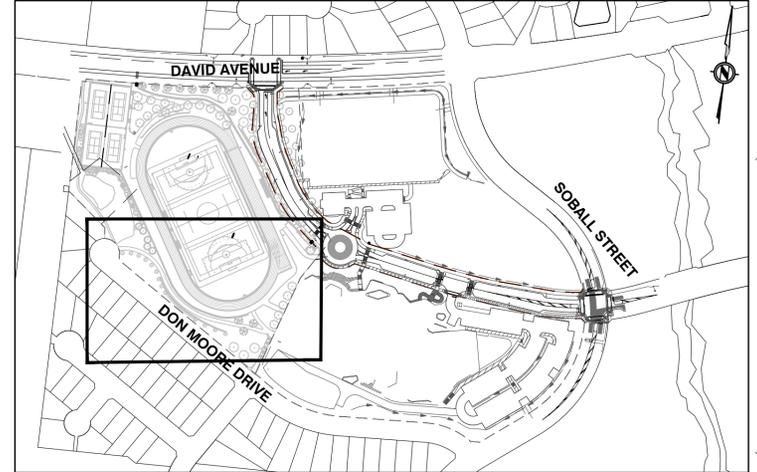

NOTE: ALL CATCH BASINS, EXCEPT ALONG RUNNEL, TO HAVE FRAME & GRATE AS PER DETAIL ON SHEET 16 OF 26.

NOTE: THE CONTRACTOR SHALL REQUEST APPROVAL FROM THE GEOTECHNICAL ENGINEER BEFORE EXCAVATING WITHIN THE GEOGRID ZONE BEHIND THE LOCK BLOCK WALLS. REVIEW DURING EXCAVATION MAY BE REQUIRED BY A REPRESENTATIVE FROM THE GEOTECHNICAL CONSULTANT.

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NOT FOR CONSTRUCTION

Edge of pavement	Hydrant	Sanitary service	Hydro Guy Wire
Watermain and valve	Water air valve	Sanitary cleanout	Hydro Kiosk
Drainage sewer, MH	Water blowoff	Utility pole (joint pole)	Vegetation Conifer
Drainage ditch	Water service	Utility pole with light	Vegetation Deciduous
Sanitary sewer, MH	Catch basin, top inlet	Streetlight, dovit	Vegetation Shrub
Sanitary forcemain	Catch basin, side inlet	Streetlight, post top	Survey Traverse Hub
Gasmain and valve	Catch basin, round	Comb. signal pole	Survey Iron Pin
Hydro duct, MH	Drainage service	Traffic signal pole	Survey Lead Plug
Telephone duct, MH	Drainage cleanout	Junction box	Survey Monument

No.	Date	By	Revisions
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5	2025-01-17	RJB	ISSUED FOR RFP REVIEW
4	2024-12-16	RJB	ISSUED FOR 100% REVIEW
3	2024-11-28	RJB	ISSUED FOR 80% REVIEW
2	2024-07-10	RJB	ISSUED FOR ALTERNATIVE COSTING
1	2024-05-08	RJB	ISSUED FOR 75% REVIEW

Design by: ASB Date: MAY, 2024

Drawn by: ASB Date: MAY, 2024

Checked by: RJB Date: MAY, 2024

Approved by: RJB Date: MAY, 2024

APLIN MARTIN

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Email: general@aplinmartin.com

ACCEPTED FOR CONSTRUCTION

Date: _____

Manager of Development Servicing

Coquitlam

Engineering & Public Works

3000 Guildford Way, Coquitlam, B.C. V3B 7N2

Scale: 1:250

Sheet of: 14 of 26











Eng. Project No: PROJ 25-015

Project: **BURKE MOUNTAIN ATHLETIC PARK**

Description: **STORM SERVICING PLAN - SOUTH**

File: 18-264A

MAY 05 2025 - 11:43am MA\SUR-LD\18-2644\DWG\ON SITE - PRODUCTION\18-2644 - STORM SERVICING PLAN DETAILS.dwg/13 STORM SERVICING PLAN - DETAILS - ABR

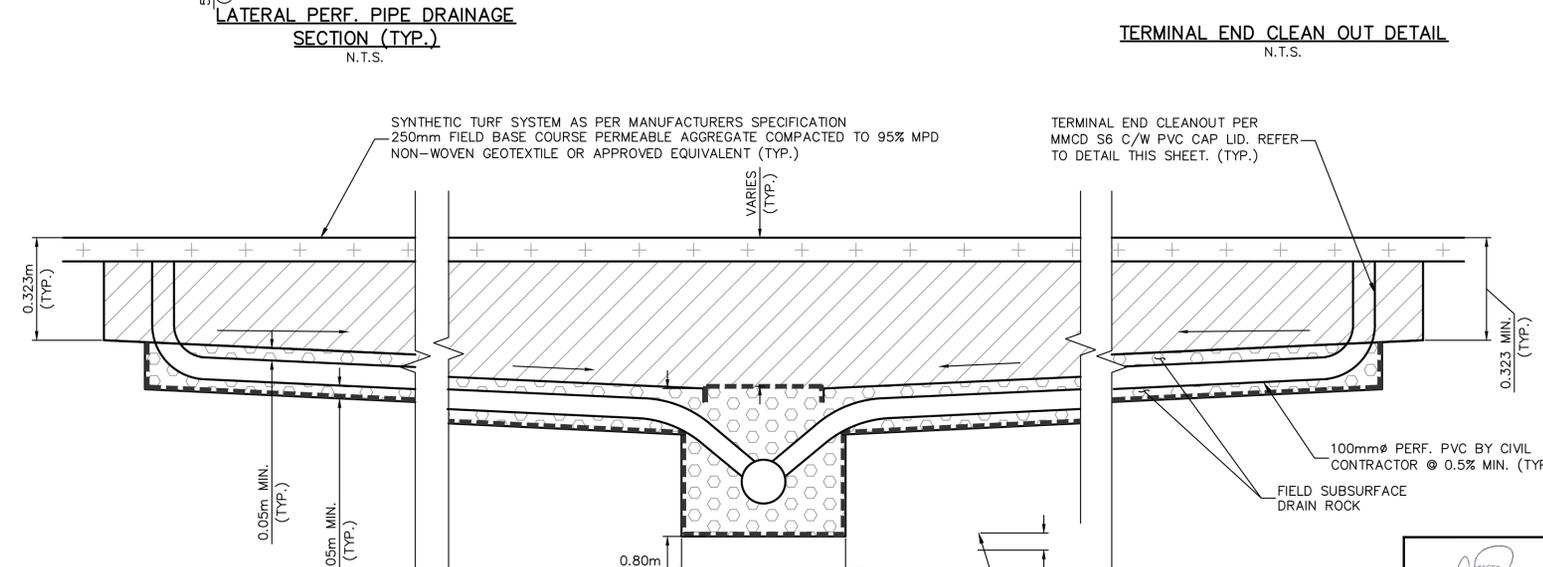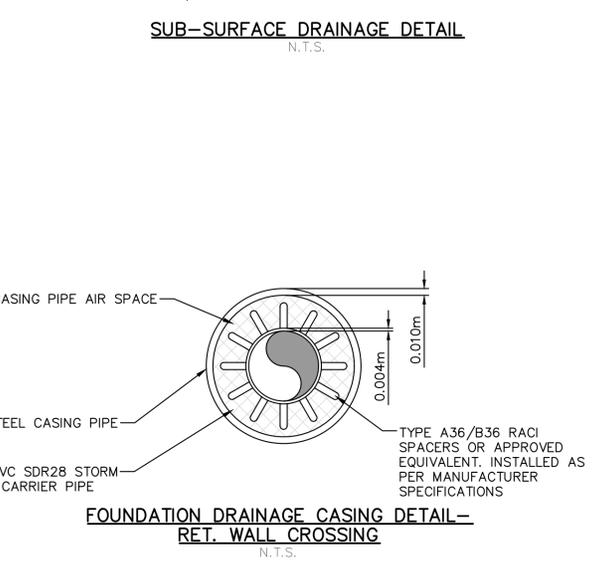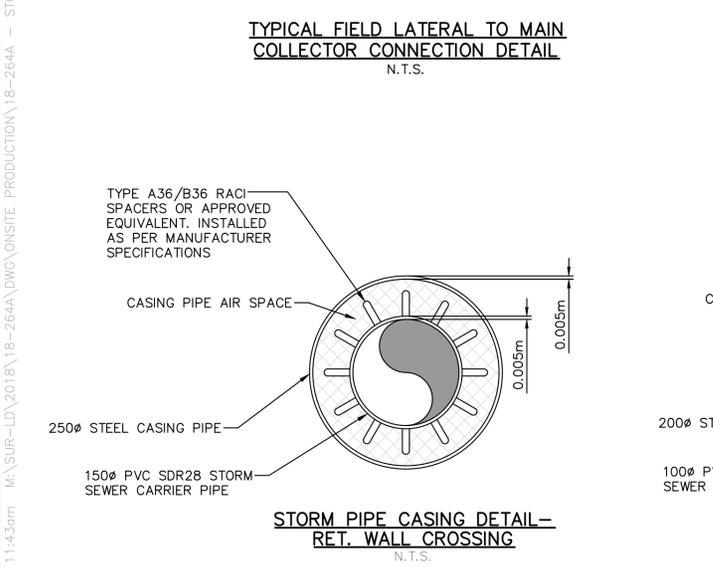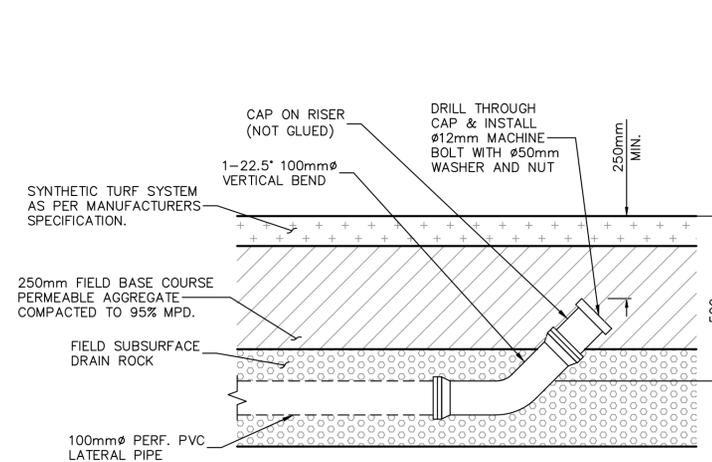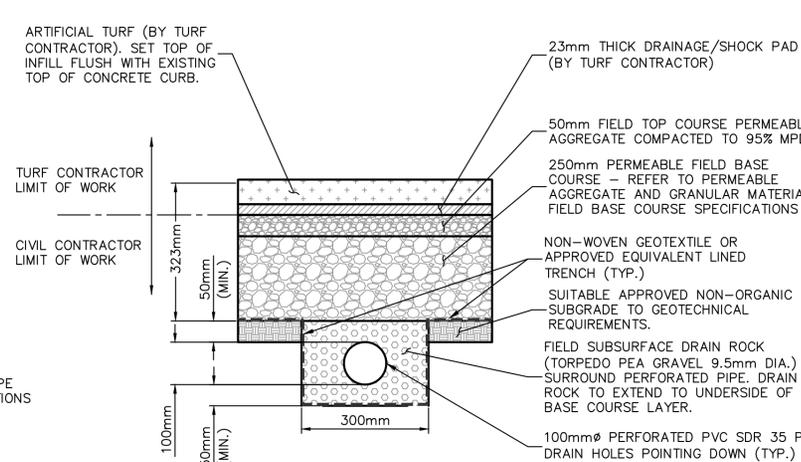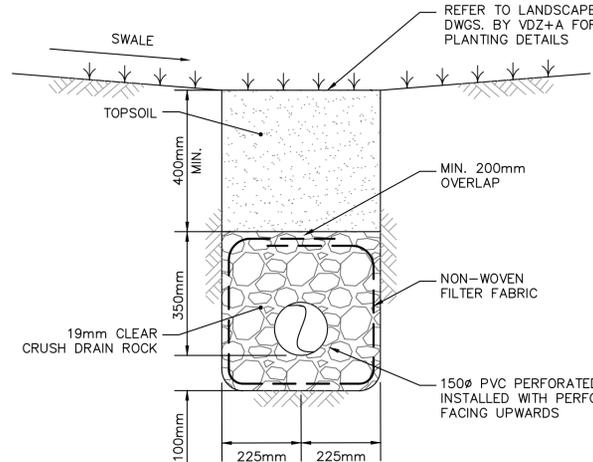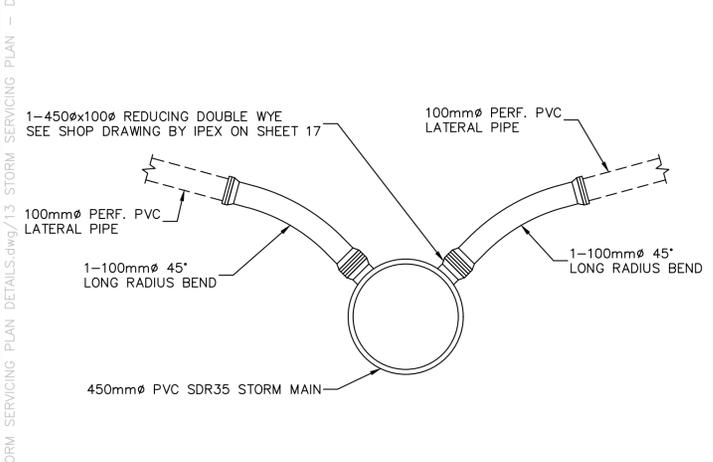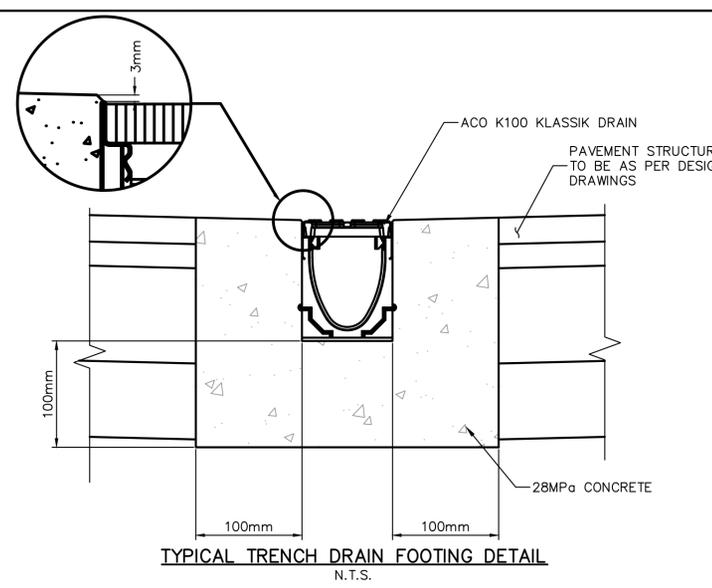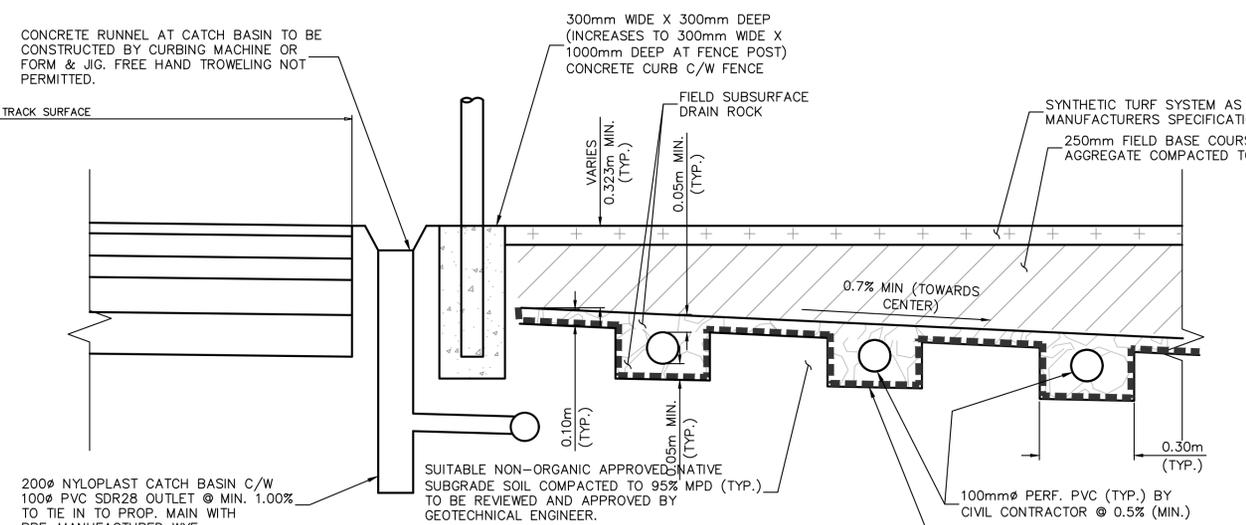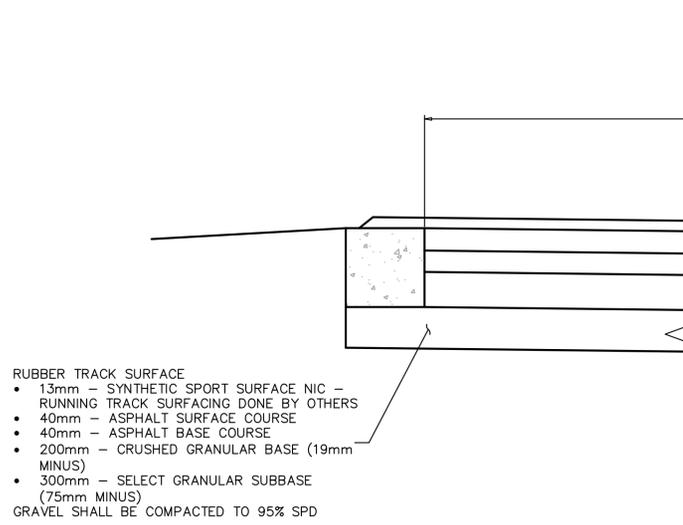

Edge of pavement	Hydrant	Sanitary service	Hydro Guy Wire
Watermain and valve	Water air valve	Sanitary cleanout	Hydro Kiosk
Drainage sewer, MH	Water blowoff	Utility pole (joint pole)	Vegetation Conifer
Drainage ditch	Water service	Utility pole with light	Vegetation Deciduous
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Gasmain and valve	Catch basin, round	Comb signal pole	Survey Iron Pin
Hydro duct, MH	Drainage service	Traffic signal pole	Survey Lead Plug
Telephone duct, MH	Drainage cleanout	Junction box	Survey Monument

No.	Date	By	Revisions
7	2025-05-05	RJB	ISSUED FOR RFP
6	2025-04-24	RJB	REISSUED FOR RFP REVIEW
5	2025-01-17	RJB	ISSUED FOR RFP REVIEW
4	2024-12-16	RJB	ISSUED FOR 100% REVIEW
3	2024-11-28	RJB	ISSUED FOR 85% REVIEW
2	2024-07-10	RJB	ISSUED FOR ALTERNATIVE COSTING
1	2024-05-08	RJB	ISSUED FOR 75% REVIEW

Design by: ASB Date: MAY, 2024

Drawn by: ASB Date: MAY, 2024

Checked by: RJB Date: MAY, 2024

Approved by: RJB Date: MAY, 2024

APLIN MARTIN

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Email: general@aplinmartin.com

ACCEPTED FOR CONSTRUCTION

Date: _____

Manager of Development Servicing

Coquitlam

Engineering & Public Works

3000 Guildford Way, Coquitlam, B.C. V3B 7N2

Scale horiz. N/A Scale vert. N/A


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Eng. Project No. PROJ 25-015


Project: **BURKE MOUNTAIN ATHLETIC PARK**

Description: **STORM SERVICING PLAN - DETAILS**






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MAY 05 2025 11:43am MA\SUR-LD\2018\18-2644\DWG\ONSITE PRODUCTION\18-2644 - STORM SERVICING PLAN - DETAILS.dwg - 2 - Abrar

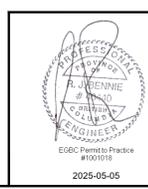

CATCH BASIN FRAME & GRATE (TYP.)
N.T.S.

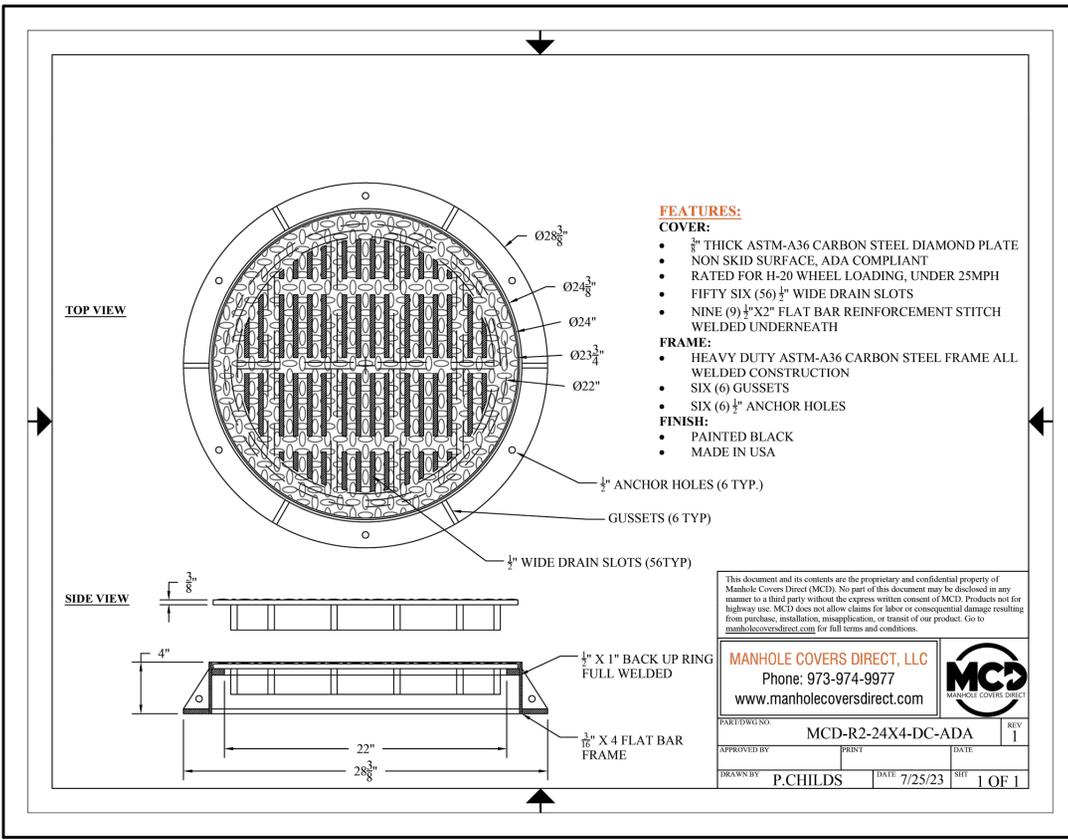

Edge of pavement	Hydrant	Sanitary service	Hydro Guy Wire
Watermain and valve	Water air valve	Sanitary cleanout	Hydro Kiosk
Drainage sewer, MH	Water blowoff	Utility pole (joint pole)	Vegetation Conifer
Drainage ditch	Water service	Utility pole with light	Vegetation Deciduous
Sanitary sewer, MH	Catch basin, top inlet	Streetlight, dovit	Vegetation Shrub
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1	2024-05-08	RJB	ISSUED FOR 75% REVIEW

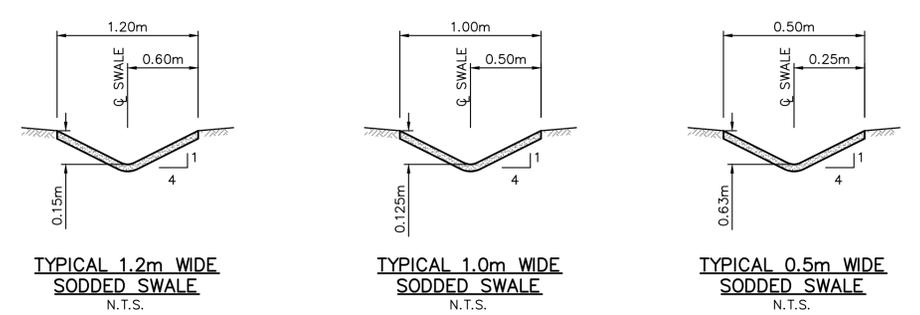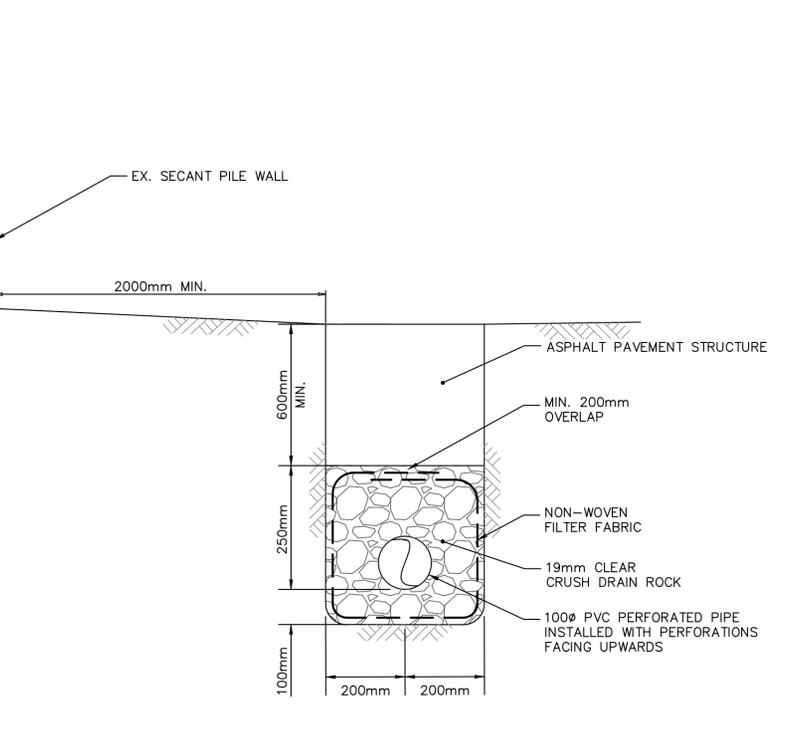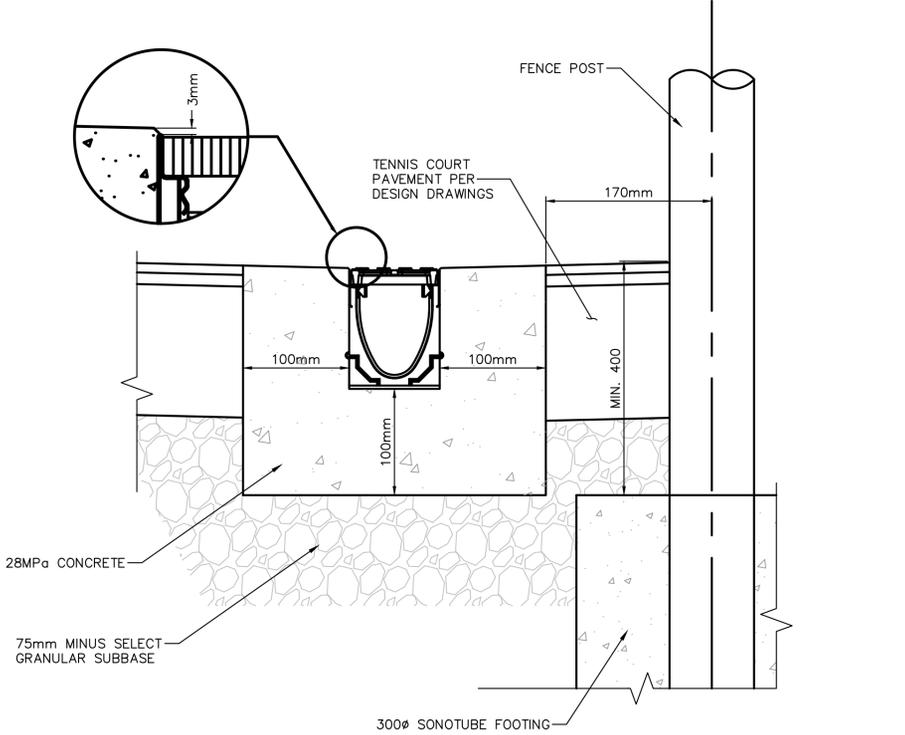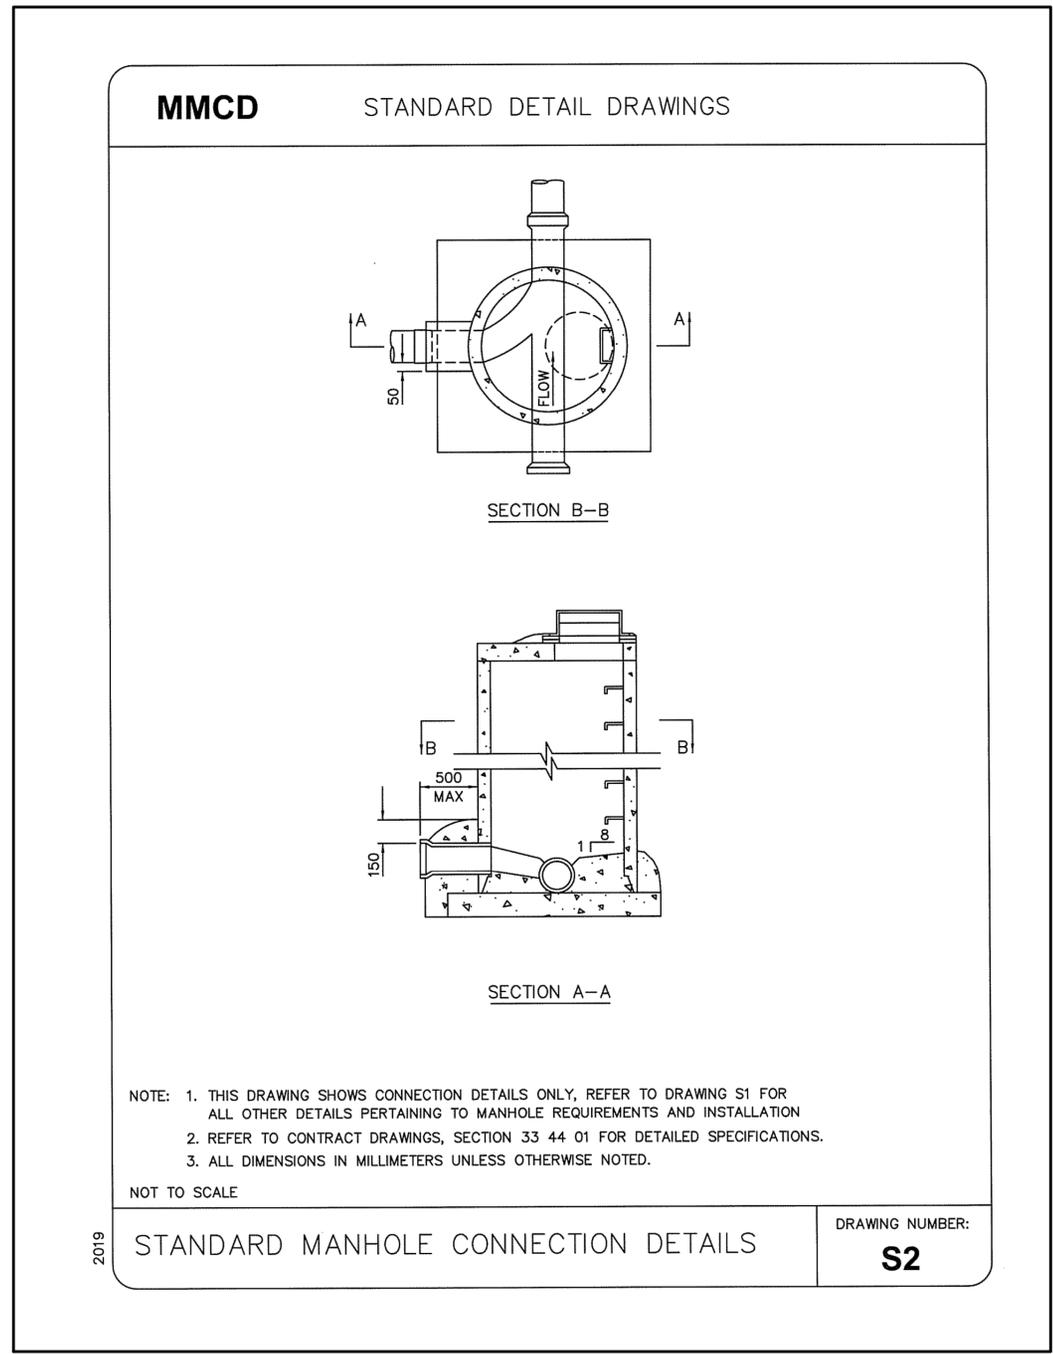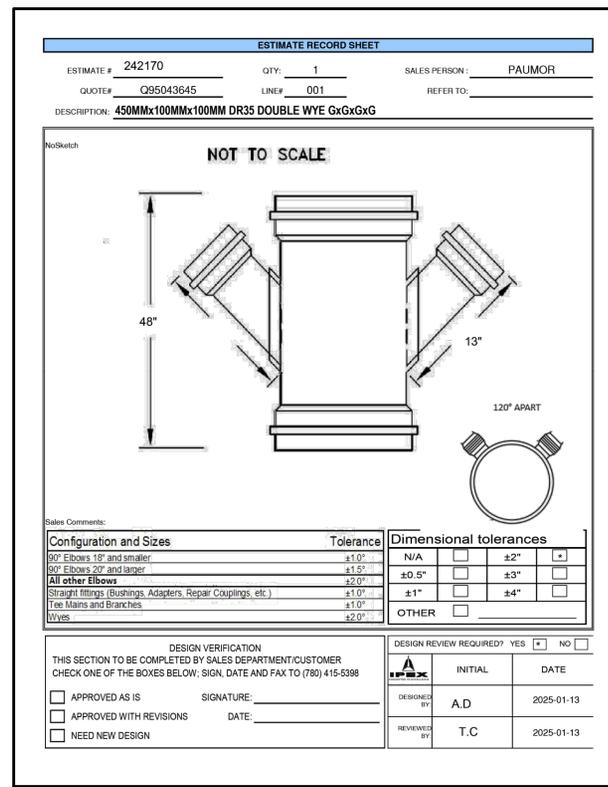Design by: ASB **Date:** MAY, 2024
Drawn by: ASB **Date:** MAY, 2024
Checked by: RJB **Date:** MAY, 2024
Approved by: RJB **Date:** MAY, 2024

APLIN MARTIN
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 Email: general@aplinmartin.com

ACCEPTED FOR CONSTRUCTION
 Date: _____
 Manager of Development Servicing


Coquitlam
 Engineering & Public Works
 3000 Guildford Way, Coquitlam, B.C. V3B 7N2

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Sheet of	16 of 26		
Eng. Project No.	PROJ 25-015		


Project: BURKE MOUNTAIN ATHLETIC PARK
Description: STORM SERVICING PLAN - DETAILS - 2
 File: 18-264A

EGBC Permit to Practice #1001018
 2025-05-05


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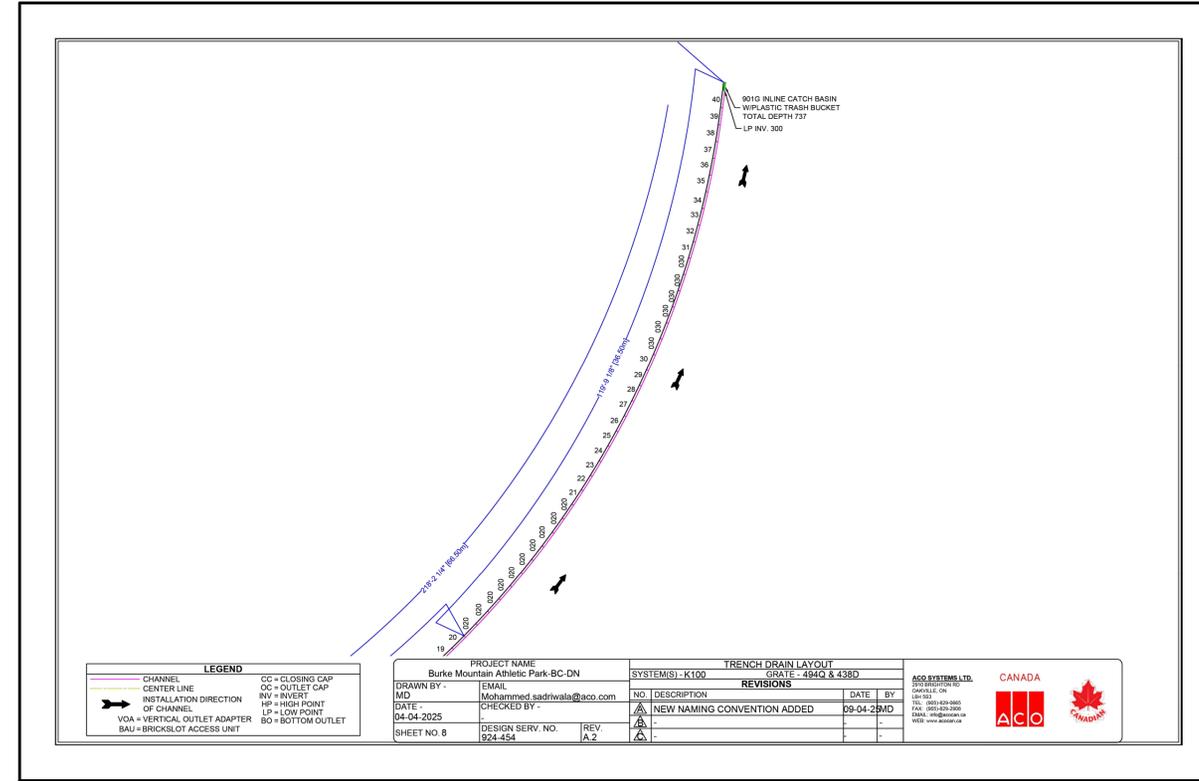
RUNNING TRACK WEST TRENCH DRAIN DETAIL
N.T.S.

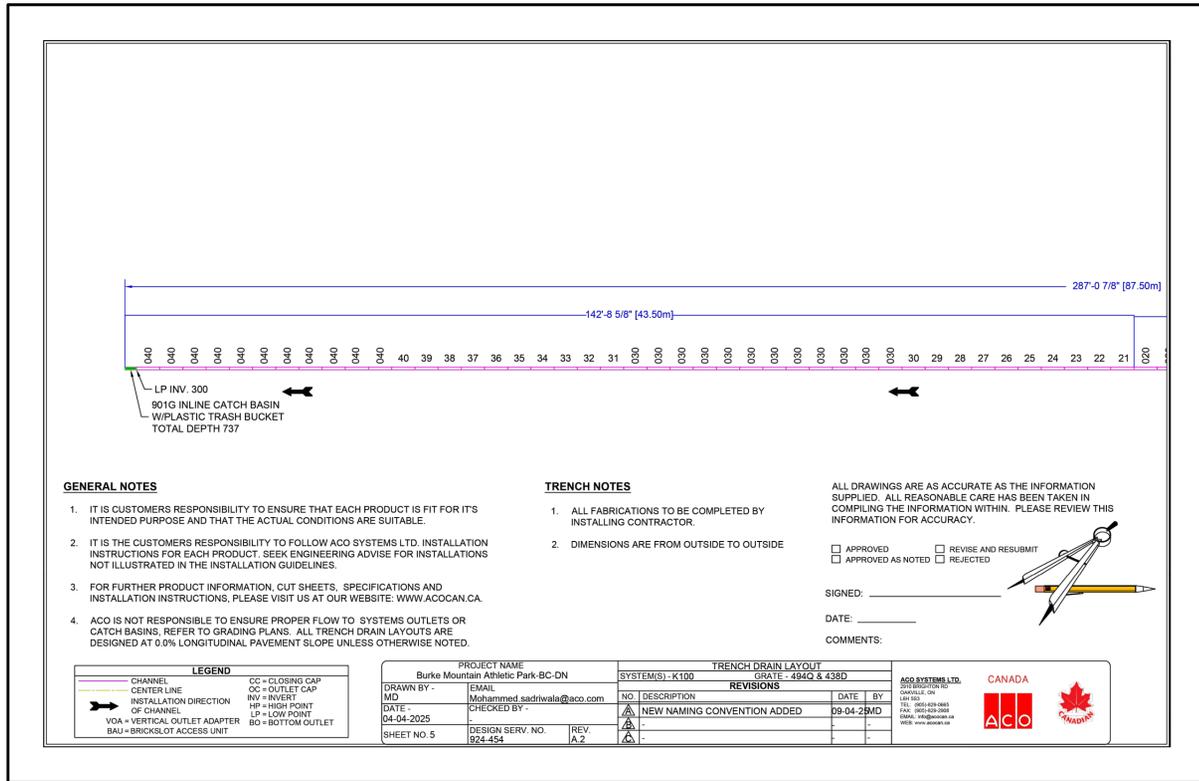

RUNNING TRACK WEST TRENCH DRAIN DETAIL
N.T.S.

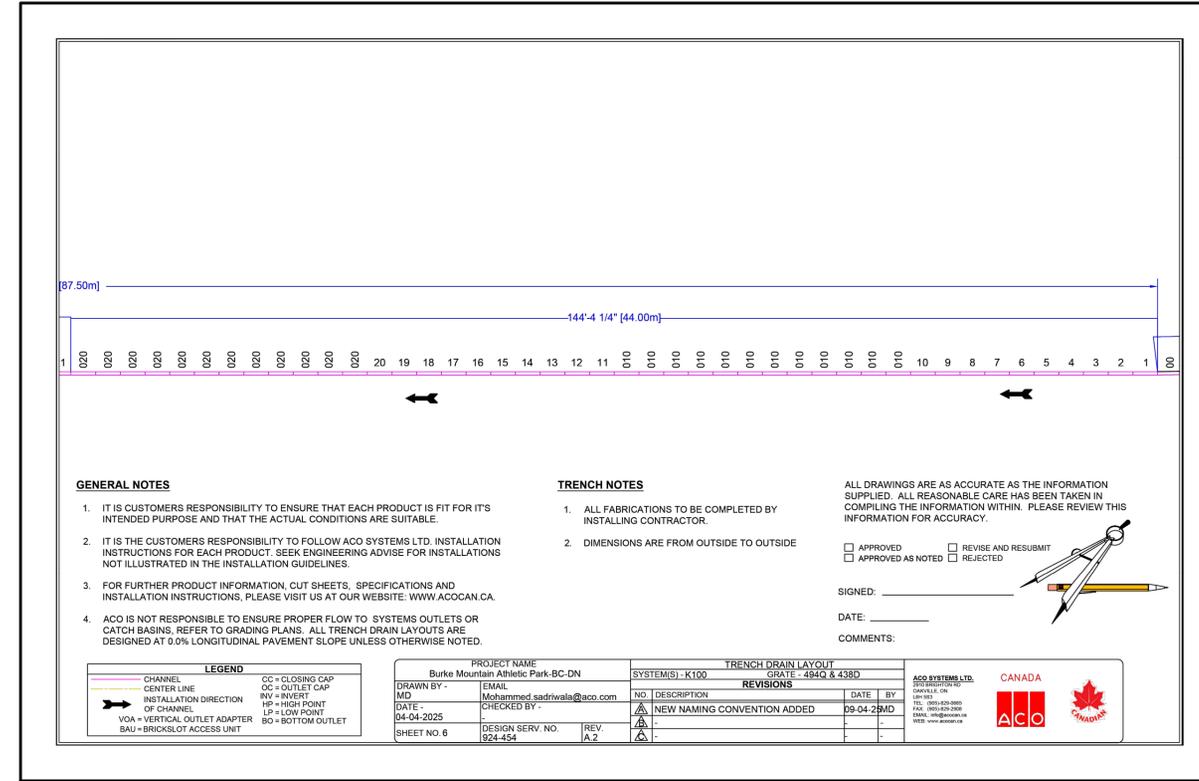

RUNNING TRACK WEST TRENCH DRAIN DETAIL
N.T.S.

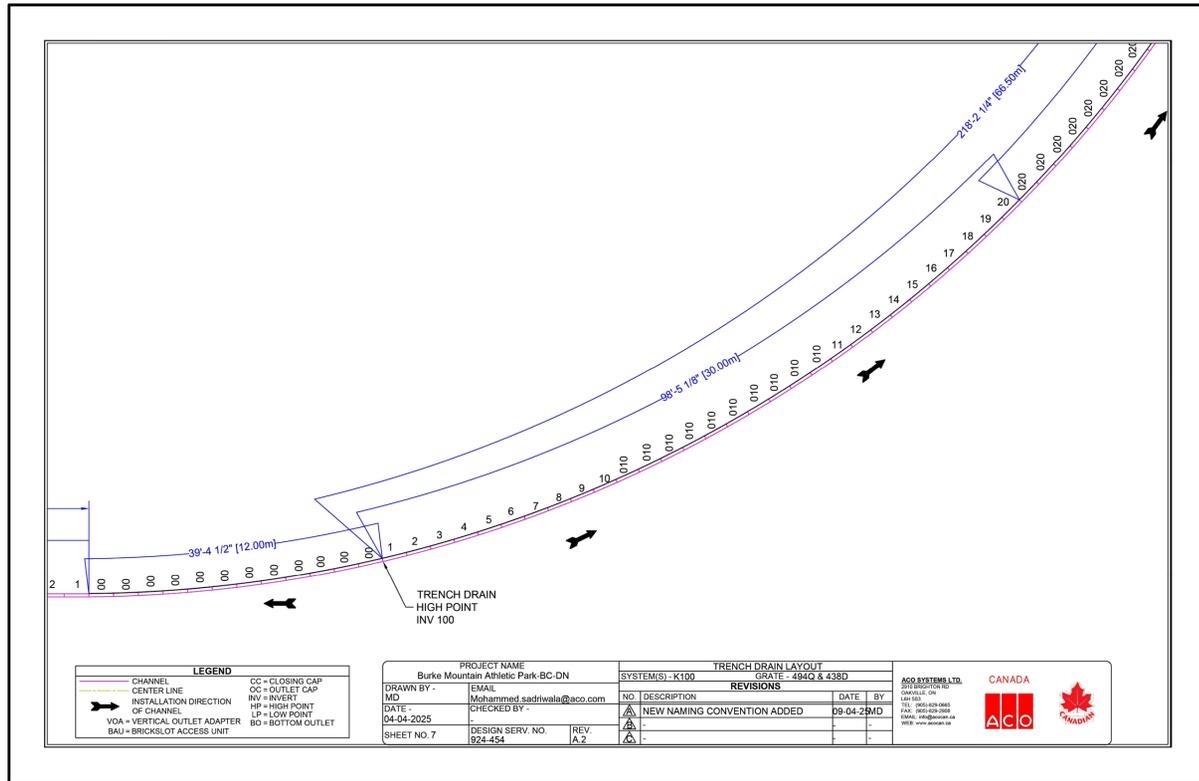

RUNNING TRACK WEST TRENCH DRAIN DETAIL
N.T.S.

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Watermain and valve	Water air valve	Sanitary cleanout	Hydro Kiosk
Drainage sewer, MH	Water blowoff	Utility pole (joint pole)	Vegetation Conifer
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ACCEPTED FOR CONSTRUCTION
 Date: _____
 Manager of Development Servicing

Coquitlam
 Engineering & Public Works
 3000 Guildford Way, Coquitlam, B.C. V3B 7N2

Scale horiz. N/A Scale vert. N/A


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Eng. Project No. **PROJ 25-015**



Project: **BURKE MOUNTAIN ATHLETIC PARK**

Description: **STORM SERVICING PLAN - DETAILS - 4**

File: 18-264A

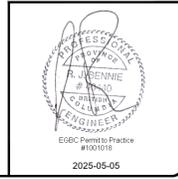


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TYPICAL DRAWING NOT FOR CONSTRUCTION

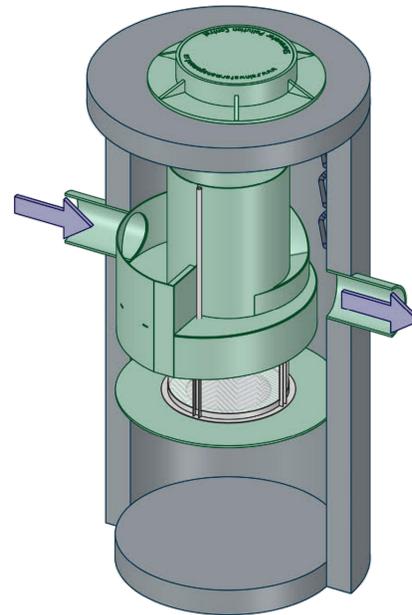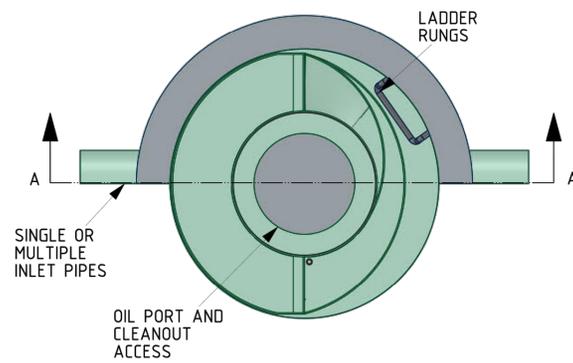SCALE 1:38



DESIGN NOTES

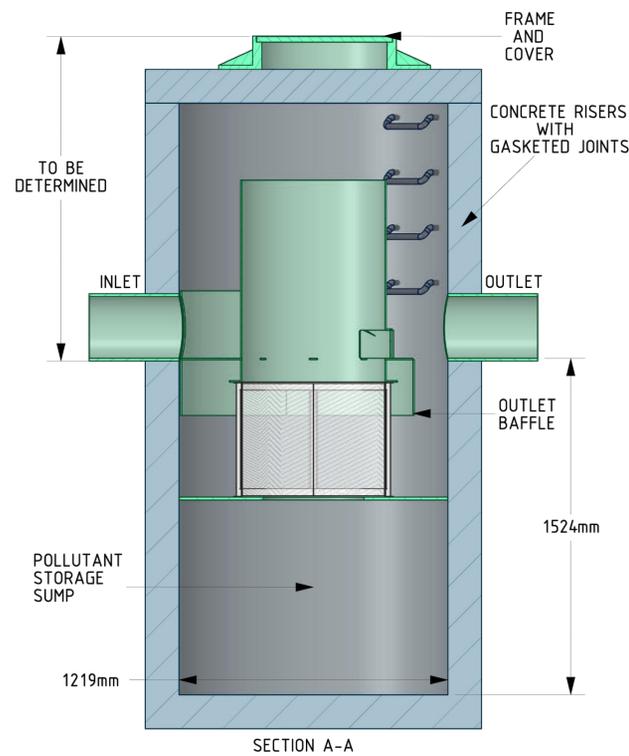
1. INLET AND OUTLET PIPE CAN BE UP TO 90 DEGREES APART DEPENDING ON PIPE AND MANHOLE SIZE. IF IN DOUBT, PLEASE CONTACT RAINWATER MANAGEMENT.
2. THE RWM SS UNIT CAN HANDLE MULTIPLE INLET PIPES AS WELL AS A TOP INLET.

GENERAL NOTES

1. RAINWATER MANAGEMENT TO PROVIDE ALL MATERIALS UNLESS NOTED OTHERWISE.
2. ALL DIMENSIONS ARE SHOWN IN MILLIMETERS.
3. FOR FABRICATION DRAWINGS WITH DETAILED STRUCTURE DIMENSIONS AND WEIGHTS, CONTACT RAINWATER MANAGEMENT. www.rainwatermanagement.ca
4. RWM WATER QUALITY STRUCTURE SHALL BE IN ACCORDANCE WITH ALL DESIGN DATA AND INFORMATION CONTAINED IN THIS DRAWING.
5. STRUCTURE AND CASTINGS SHALL MEET REQUIRED LOAD RATINGS, ASSUMING GROUNDWATER ELEVATION AT, OR BELOW THE OUTLET PIPE INVERT ELEVATION. ENGINEER OF RECORD TO CONFIRM ACTUAL GROUNDWATER ELEVATION.
6. MANHOLE MANUFACTURED TO LOCAL SPECIFICATIONS.

INSTALLATION NOTES

1. ANY SUB-BASE, BACKFILL DEPTH, AND/OR ANTI-FLOTATION PROVISIONS ARE SITE-SPECIFIC DESIGN CONSIDERATIONS AND SHALL BE SPECIFIED BY THE ENGINEER OF RECORD.
2. CONTRACTOR TO PROVIDE EQUIPMENT WITH SUFFICIENT LIFTING AND REACH CAPACITY TO LIFT AND SET THE MANHOLE STRUCTURE (LIFTING DEVICES NOT PROVIDED). HEAVIEST LIFT DEPENDS ON RISER HEIGHTS.
3. CONTRACTOR TO ADD GASKETS OR JOINT SEALANT BETWEEN ALL STRUCTURE SECTIONS, AND ASSEMBLE STRUCTURE AS REQUIRED.
4. CONTRACTOR TO PROVIDE, INSTALL, AND GROUT PIPES, MATCH PIPE INVERTS WITH ELEVATIONS SHOWN.
5. CONTRACTOR TO TAKE APPROPRIATE MEASURES TO ASSURE UNIT IS WATER TIGHT. IT IS SUGGESTED THAT ALL JOINTS BELOW PIPE INVERTS ARE GROUTED.

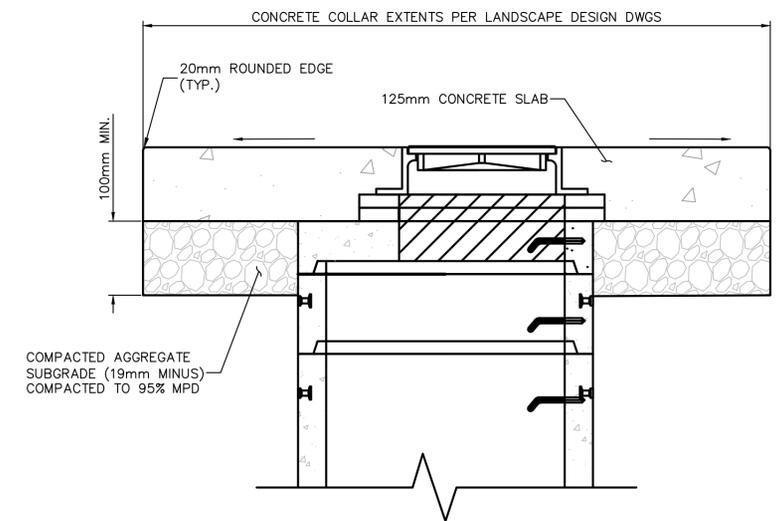

MANHOLE CONCRETE COLLAR DETAIL
N.T.S.

rainwater MANAGEMENT
www.rainwatermanagement.ca
604-944-9265

FILE RWM-SS-1200 TYPICAL		MODEL RWM-SS-1200			
JOB / IDENTIFIER SS		REV	CREATOR AG	APPROVED	SHEET 1 of 1
MATERIAL --	THICKNESS	SCALE 1:32	CREATED 10/5/2022	LAST SAVED 10/5/2022 10:02:07 AM	

Edge of pavement	Hydrant	Sanitary service	Hydro Guy Wire
Watermain and valve	Water air valve	Sanitary cleanout	Hydro Kiosk
Drainage sewer, MH	Water blowoff	Utility pole(joint pole)	Vegetation Conifer
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Design by: ASB Date: MAY, 2024

Drawn by: ASB Date: MAY, 2024

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Approved by: RJB Date: MAY, 2024

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Email: general@aplinmartin.com

ACCEPTED FOR CONSTRUCTION
Date: _____
Manager of Development Servicing

Coquitlam
Engineering & Public Works
3000 Guildford Way, Coquitlam, B.C. V3B 7N2

Scale horiz.	N/A	Scale vert.	N/A
Sheet of	19 of 26		
Eng. Project No.	PROJ 25-015		



Project: **BURKE MOUNTAIN ATHLETIC PARK**

Description: **STORM SERVICING PLAN - DETAILS - 5**


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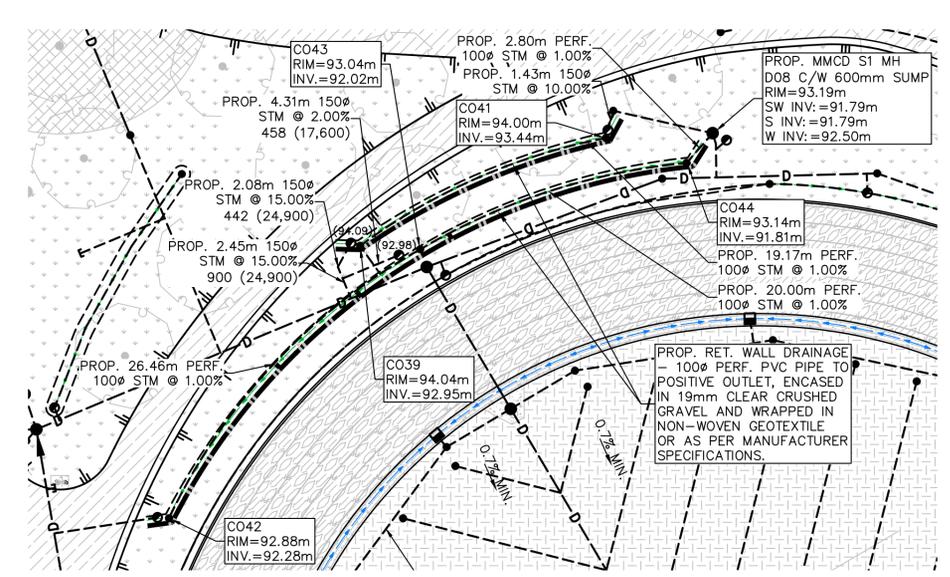
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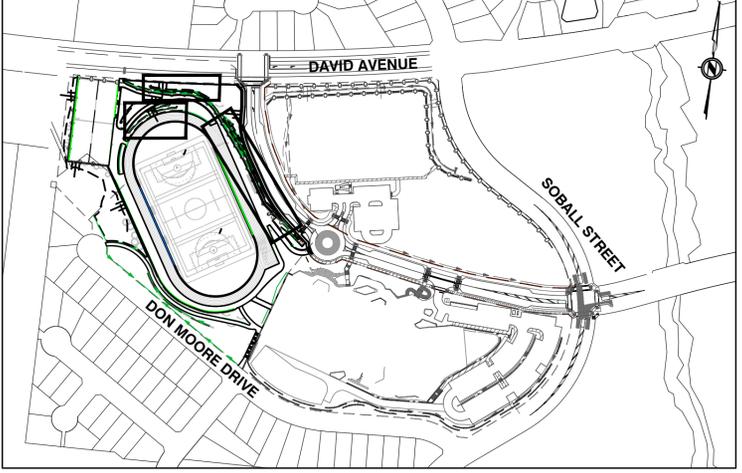
EAST RETAINING WALL DETAIL
SCALE = 1:250



RETAINING WALL 3 DETAIL
SCALE = 1:250

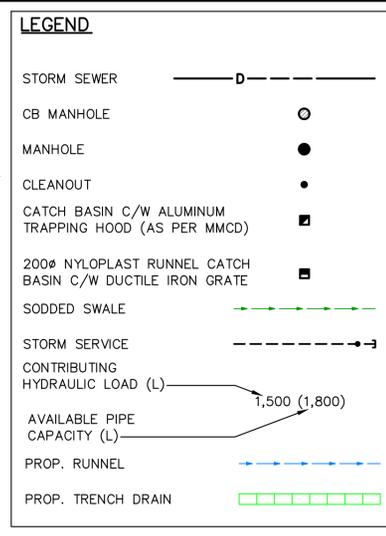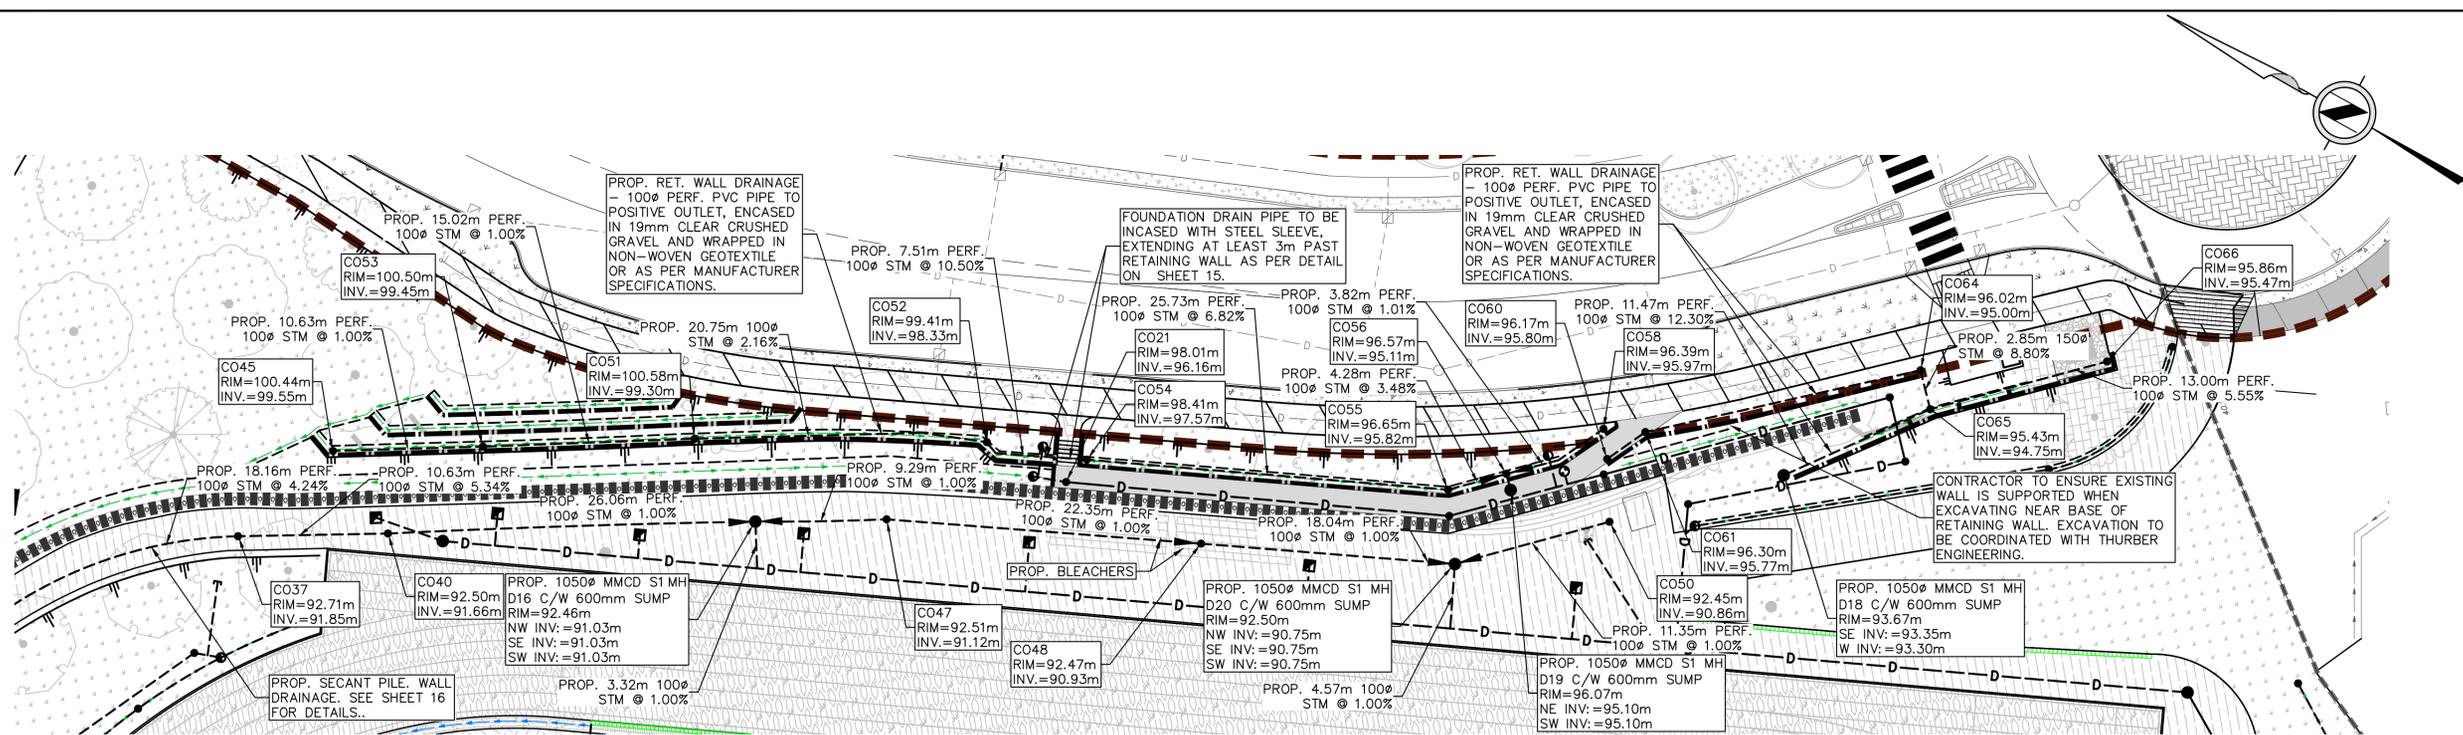

RETAINING WALL 4 & 5 DETAIL
SCALE = 1:250

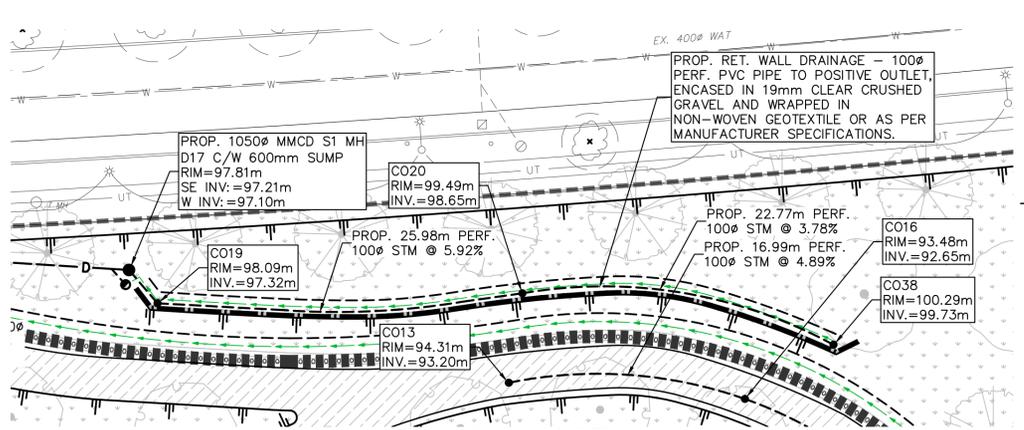

NOTE: THESE DRAWINGS ARE TO BE READ IN CONJUNCTION WITH THE CURRENT LANDSCAPE, ARCHITECTURAL, ELECTRICAL, STREETLIGHTING, GEOTECHNICAL & STRUCTURAL DRAWINGS.

NOTE: THE CONTRACTOR SHALL REQUEST APPROVAL FROM THE GEOTECHNICAL ENGINEER BEFORE EXCAVATING WITHIN THE GEOGRID ZONE BEHIND THE LOCK BLOCK WALLS. REVIEW DURING EXCAVATION MAY BE REQUIRED BY A REPRESENTATIVE FROM THE GEOTECHNICAL CONSULTANT.

NOTE: ALL CATCH BASINS, EXCEPT ALONG RUNNEL, TO HAVE FRAME & GRATE AS PER DETAIL ON SHEET 16 OF 26.

NOT FOR CONSTRUCTION



Edge of pavement	Hydrant	Sanitary service	Hydro Guy Wire
Watermain and valve	Water air valve	Sanitary cleanout	Hydro Kiosk
Drainage sewer, MH	Water blowoff	Utility pole (joint pole)	Vegetation Conifer
Drainage ditch	Water service	Utility pole with light	Vegetation Deciduous
Sanitary sewer, MH	Catch basin, top inlet	Streetlight, down	Vegetation Shrub
Sanitary forcemain	Catch basin, side inlet	Streetlight, post top	Survey Traverse Hub
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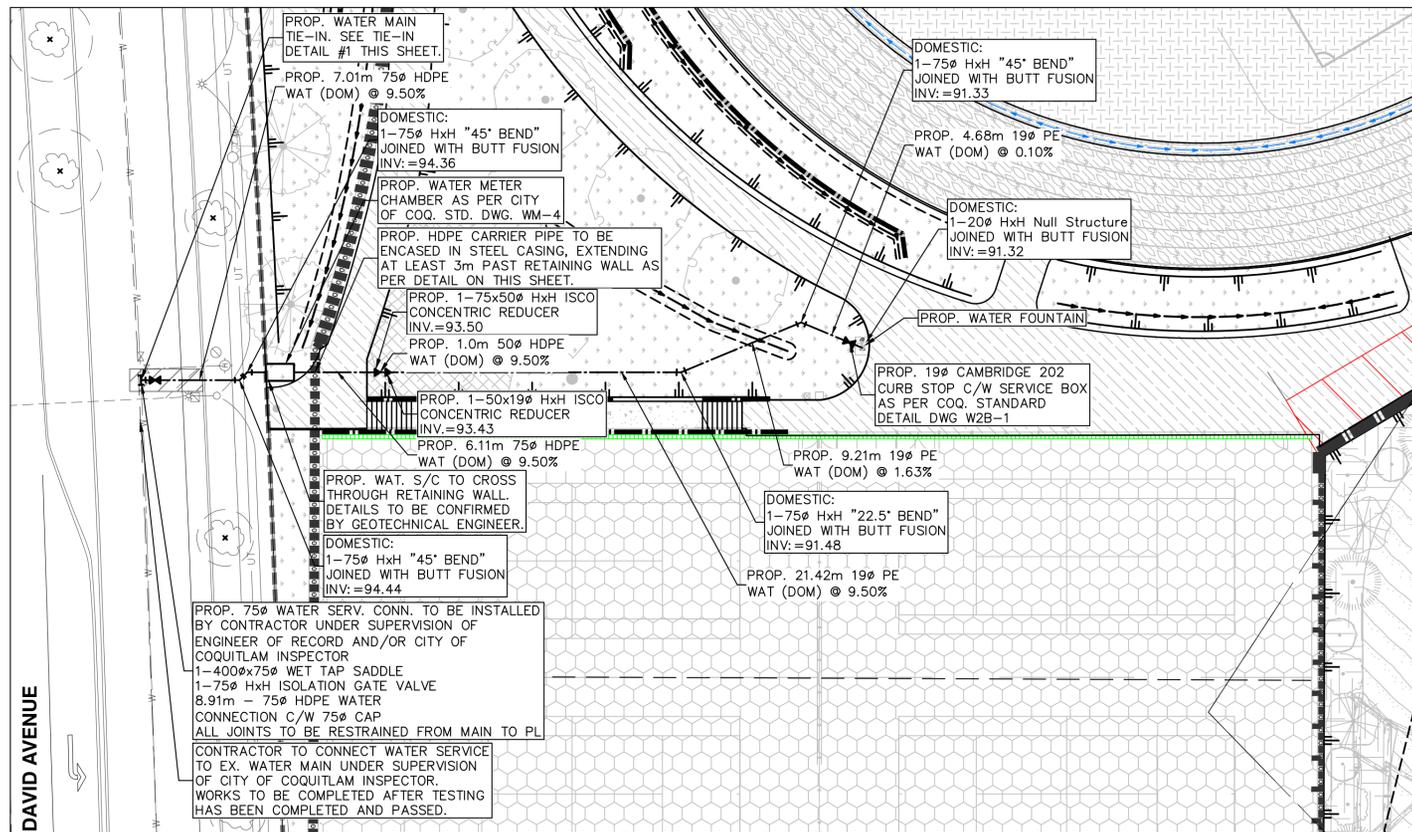
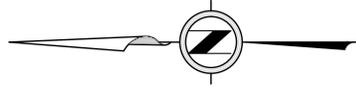
Scale horiz. 1:250 Scale vert. N/A
 Sheet of 20 of 26
 Eng. Project No. PROJ 25-015

Project: **BURKE MOUNTAIN ATHLETIC PARK**
 Description: **STORM SERVICING PLAN - FOUNDATION DRAINAGE**
 File: 18-2644


ALL JOINTS AS PER EBAA AND UNIFLANGE OR APPROVED EQUIVALENT

CONTRACTOR TO CONFIRM LOCATION, SIZE, MATERIAL & INVERT OF EXISTING SERVICES PRIOR TO CONSTRUCTION & REPORT DISCREPANCIES TO ENGINEER OF RECORD


NOTE: THESE DRAWINGS ARE TO BE READ IN CONJUNCTION WITH THE CURRENT LANDSCAPE, ARCHITECTURAL, ELECTRICAL, STREETLIGHTING, GEOTECHNICAL & STRUCTURAL DRAWINGS.




DAVID AVENUE WATER SERVICE CONNECTION PLAN
1:250

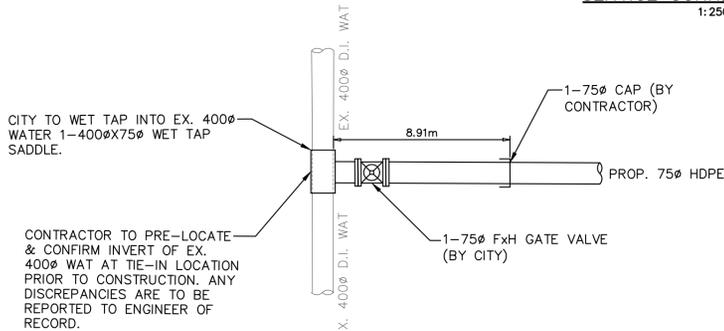


TIE-IN DETAIL #1
N.T.S.

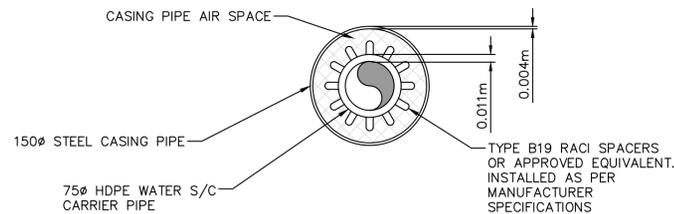

WATER PIPE CASING DETAIL - RET. WALL CROSSING
N.T.S.

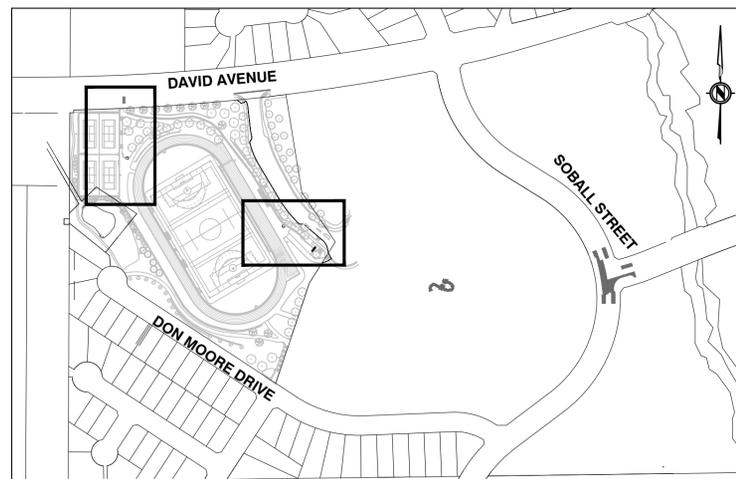

SITE LOCATION PLAN
1:3000

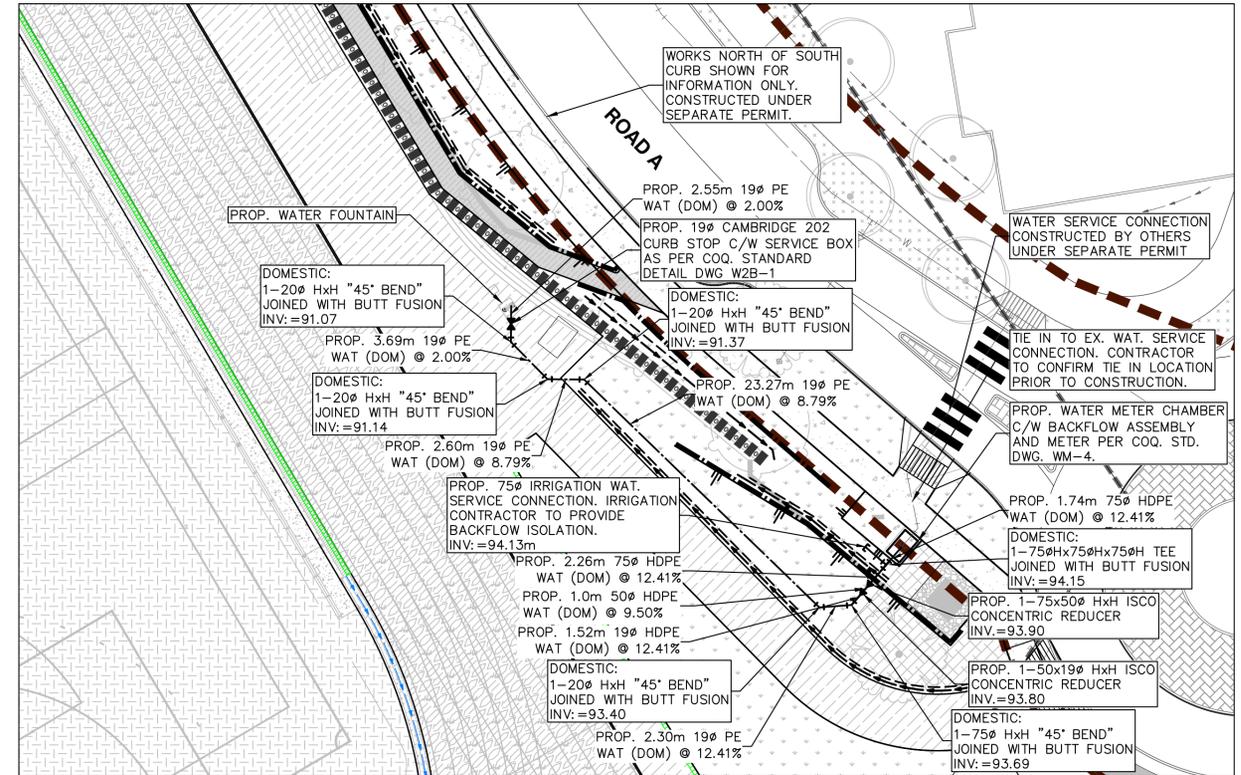

ROAD A WATER SERVICE CONNECTION PLAN
1:250

WATERWORKS NOTES:

- ALL OFF-SITE CONSTRUCTION AND MATERIALS SHALL BE IN ACCORDANCE WITH CITY OF COQUITLAM SUBDIVISION AND DEVELOPMENT SERVICING BYLAW NO. 3558, 2003 AS AMENDED FEBRUARY 2019 AND THE APPLICABLE CITY OF COQUITLAM SUPPLEMENTARY SPECIFICATIONS AND DETAILED DRAWINGS TO MMCD 2019 EDITION.
- ALL WATER & BEDDING MATERIALS TO MEET MASTER MUNICIPAL CONTRACT DOCUMENTS (MMCD) & BRITISH COLUMBIA PLUMBING CODE 2024 REQUIREMENTS.
- ALL EXISTING VALVE BOXES AND LIDS IN LIMITS OF WORK TO BE ADJUSTED TO SUIT PROPOSED SURFACE.
- CONTRACTOR TO CONFIRM LOCATIONS & SIZES OF ALL EXISTING SERVICES PRIOR TO CONSTRUCTION AND ENSURE CIVIL DRAWINGS MATCH OTHER CONTRACT DRAWINGS. ANY DISCREPANCIES MUST BE REPORTED TO BOTH ENGINEERS IMMEDIATELY.
- ALL WATERMANS TO HAVE MINIMUM 0.9m COVER.
- FOR TYPICAL UTILITY TRENCH SECTION DETAIL REFER TO MMCD STANDARD DRAWING G4.
- TESTING AND CHLORINATION IS THE RESPONSIBILITY OF THE CONTRACTOR. TESTING RESULTS TO BE APPROVED PRIOR TO PROCEEDING WITH ANY TIE-INS.
- TIE-INS TO BE COMPLETED BY CONTRACTOR UNDER SUPERVISION OF ENGINEER OF RECORD AND/OR CITY OF COQUITLAM INSPECTOR.
- SYSTEM TEST PRESSURES SHALL BE A MINIMUM OF 1.5 TIMES THE MAXIMUM OPERATING PRESSURE OR 225psi WHICHEVER IS HIGHER.
- ALL CAPS TO BE DIMENSIONED TO PROPERTY LINE FOR AS-BUILT SUBMISSION.
- SCHEDULE 40 & 80 PIPE IS NOT PERMITTED.
- FIRE LINE TO BE AWWA C900 PVC DR18 OR APPROVED EQUAL.
- DOMESTIC WATERMANS TO BE HDPE DR9 IN COMPLIANCE WITH AWWA C901 OR APPROVED EQUIVALENT AND CERTIFIED TO CAN/CSA B137.1
- BUTT FUSION FITTINGS SHALL BE MADE OF HDPE MATERIAL WITH A MIN. MATERIAL DESIGNATION CODE OF PE4710. BUTT FUSION FITTINGS SHALL MEET THE REQUIREMENTS OF ASTM D3261 AND CERTIFIED TO SERIES 200 OF CAN/CSA B137.1
- ALL HDPE FITTINGS SHALL MEET THE REQUIREMENTS OF AWWA C906.
- PIPE DEFLECTION FOR PVC PIPES AT JOINTS SHALL NOT BE MORE THAN 2.5"
- THE CONTRACTOR SHALL INFORM THE ENGINEER AND CITY OF COQUITLAM A MINIMUM OF 48 HOURS PRIOR TO REQUIRED INSPECTIONS.
- AT THE END OF CONSTRUCTION, CONTRACTOR TO PROVIDE MARKED-UP RECORD DRAWINGS TO THE ENGINEER C/W CONFIRMED LOCATIONS AND ELEVATIONS OF INSTALLED UTILITIES.

GENERAL NOTES:

- CONTRACTOR SHALL EXPOSE ALL UTILITY CROSSINGS AND ALL TIE-IN LOCATIONS TO VERIFY LOCATION AND ELEVATION MINIMUM 4 BUSINESS DAYS PRIOR TO WATER MAIN CONSTRUCTION. ANY CONFLICTS OR DISCREPANCIES SHALL BE REPORTED TO THE ENGINEER IN WRITING IMMEDIATELY.
- THE CONTRACTOR SHALL MAINTAIN ALL MUNICIPAL ROADS PROVIDING ACCESS TO THE CONSTRUCTION SITE AND ARRANGE FOR DAILY STREET CLEANING DURING TIMES OF CONSTRUCTION OR MORE OFTEN, IF REQUIRED.
- THE CONTRACTOR MUST CONTACT THE ENGINEER PRIOR TO CONSTRUCTION TO SCHEDULE AN ON-SITE PRE-CONSTRUCTION MEETING DURING WHICH CONSTRUCTION METHODS, TIMING, AND INSPECTION WILL BE DISCUSSED.
- CONTRACTOR TO USE LOW IMPACT CONSTRUCTION METHODS AND TO CONTACT ARBORIST FOR SUPERVISION WHEN COMPLETING WORK AROUND TREES.
- CONTRACTOR IS TO RESTORE ANY AND ALL WALKWAYS, PAVEMENTS, DRIVEWAYS, FENCING, AND LANDSCAPING DISTURBED DURING THE COURSE OF CONSTRUCTION TO THE SATISFACTION OF THE ENGINEER AND CITY.



2025-05-05

Edge of pavement	Hydrant	Sanitary service	Hydro Guy Wire
Watermain and valve	Water air valve	Sanitary cleanout	Hydro Kiosk
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Telephone duct, MH	Drainage cleanout	Junction box	Survey Monument

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7	2025-05-05	RJB	ISSUED FOR RFP
6	2025-04-24	RJB	REISSUED FOR RFP REVIEW
5	2025-01-17	RJB	ISSUED FOR RFP REVIEW
4	2024-12-16	RJB	ISSUED FOR 100% REVIEW
3	2024-11-28	RJB	ISSUED FOR 85% REVIEW
2	2024-07-10	RJB	ISSUED FOR ALTERNATIVE COSTING
1	2024-05-08	RJB	ISSUED FOR 75% REVIEW

Design by: ASB Date: MAY, 2024
 Drawn by: ASB Date: MAY, 2024
 Checked by: RJB Date: MAY, 2024
 Approved by: RJB Date: MAY, 2024

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 Email: general@aplinmartin.com

ACCEPTED FOR CONSTRUCTION
 Date: _____
 Manager of Development Servicing

Coquitlam
 Engineering & Public Works
 3000 Guildford Way, Coquitlam, B.C. V3B 7N2

Scale horiz. 1:250 Scale vert. N/A
 Sheet of 21 of 26
 Eng. Project No. PROJ 25-015

Project: **BURKE MOUNTAIN ATHLETIC PARK**
 Description: **WATER SERVICING PLAN**
 File: 18-264A

LEGEND

- SILT FENCE
- LOCK-BLOCK RETAINING WALL
- SECANT PILE RETAINING WALL
- INLET PROTECTION AT EX. CATCH BASINS AND LAWN BASINS
- INLET PROTECTION AT PROP. CATCH BASINS AND LAWN BASINS
- ESC MONITORING POINT
- PROPOSED SUMP PUMP
- OVERLAND FLOW DIRECTION
- CONSTRUCTION ENTRANCE PAD
- COIR MAT
- PROPOSED STRAW /HAY (4.5 TONNES/HECTARE)

NOTES: STAGE 1 – EARTHWORKS

SEDIMENT & EROSION CONTROL DURING THE CLEARING PHASE IS TO BE COMPLETED BY THE CONTRACTOR AS FOLLOWS:

- ALL TRUCK TRAFFIC LEAVING SITE MUST EXIT THROUGH GRAVEL/COMMERCIAL PAD.
- THE CONTRACTOR SHALL LIMIT TRAFFIC OVER THE SITE TO AREAS OF IMMEDIATE CONSTRUCTION ONLY, THROUGH THE USE OF HAUL ROADS AND MARKING OFF 'NO GO' AREAS WITH BARRIER FENCE.
- TEMPORARY STOCKPILES OF EXCAVATED MATERIAL ARE TO BE PROTECTED WITH POLY SHEETING (OR SIMILAR) AND SURROUNDED BY SILT FENCE TO MINIMIZE SOIL EROSION DUE TO RAINFALL EVENTS AS PER DETAIL ON SHEET 22.
- CONTRACTOR TO PROTECT EXISTING TREES AS NECESSARY IN ACCORDANCE WITH THE TREE PRESERVATION PLAN.

NOTE
PROP. TOTAL PRE-TREATMENT DETENTION VOLUME TO BE PROVIDED AS A COMBINATION OF TANKS AND PONDS

NOTE
ESC ADVISORY SIGN TO BE MAINTAINED AS REQUIRED UNTIL THE ESC PERMIT IS CLOSED.

NOTE
1. CONTRACTOR TO MAINTAIN ALL INSTALLED ESC FACILITIES AS NEEDED.
2. ESC FACILITIES TO BE ONLY REMOVED UPON ESC SUPERVISOR'S APPROVAL.

ESC HOLDING TANK & TREATMENT UNIT - CALCULATION SHEET

MUN. PROJECT #:	A&M Project No:	18-264A
PROJECT TITLE:	Sheet:	1 of 1
PROJECT LOCATION:	Date:	Jan-14-25
3390 & 3400 David Avenue	By:	SY
	Chk:	ASB

Treatment Unit Calculations

	Storm Duration min	Runoff coefficient %	Area Ha	Intensity mm	n	Q cms
Q _T (10 Year - 24hr)	1440	0.70	3.25	6	0.00278	0.035

Design Flow Calculations

	T _c min	Runoff coefficient %	Area Ha	Intensity mm	n	Q cms
Q _D (10 Year)	30	0.70	3.25	29	0.00278	0.184

Holding Pond Volume Calculations (Modified Rational Method)

Storage Volume = $T_r (Q_{D2} - Q_T) + 0.5 \times T_c \times Q_T^2 (1/Q_{D2} - 1/Q_{D1})$

T_r = Duration of storm, in seconds
 T_c = Time to concentration, in seconds
 Q_{D1} = Peak flow for storm, $T_r = T_c$, cms
 Q_{D2} = Peak flow for storm specified, cms
 Q_T = Treatment unit flow rate, cms

Minimum Storage Required = **627 cm**
 Min. Combined Volume of Sumps and Tank

Rainfall Duration Tr min	Rainfall Intensity I mm	Peak Flow Q _{p1} cms	Peak Flow Q _{p2} cms	Required Storage cm
200	13	0.184	0.082	566
250	12	0.184	0.074	596
300	11	0.184	0.069	614
350	10	0.184	0.064	624
400	10	0.184	0.061	627
450	9	0.184	0.058	624
500	9	0.184	0.055	616
550	8	0.184	0.053	604
600	8	0.184	0.051	589
650	8	0.184	0.049	571
700	8	0.184	0.048	550
750	7	0.184	0.046	526
800	7	0.184	0.045	500
850	7	0.184	0.044	471
900	7	0.184	0.043	441

EROSION & SEDIMENT CONTROL PROGRAM IN EFFECT

BY CITY REGULATION BYLAW NO. 4403, 2013

Erosion and sediment control facilities have been installed on this site and are to be maintained for the duration of development to control site erosion and reduce the amount of sediment entering the drainage system and creeks. This site is monitored regularly by an Erosion and Sediment Control Supervisor, and is inspected by the City of Coquitlam. If the site requires attention, please contact:

[Mark Boston, BC-CESCL, Field Inspector]
 [604-597-9058]
 OR
 City of Coquitlam Customer Service Hotline 604-927-3500
 Reference Site Address: 3390 & 3400 David Avenue
 Reference City Permit#: PROJ 25-015

NOTES:


- DIMENSIONS: 600mm HEIGHT X 900mm WIDTH
- SIGN SHALL BE CONSTRUCTED OF WATERPROOF MATERIALS, POSTED IN A LOCATION VISIBLE FROM OFFSITE, AND REMAIN POSTED DURING THE DEVELOPMENT.
- SIGN SHALL HAVE BLACK LETTERING ON A WHITE BACKGROUND

EROSION AND SEDIMENT CONTROL ADVISORY SIGN

N.T.S.

ESC MONITORING

- A pH VALUE OUTSIDE THE RANGE OF 6.5 TO 8.0; OR
- A DISCHARGE EXCEEDING A TURBIDITY LEVEL OF 25 NTU, EXCEPT DURING AND FOR 24 HOURS FOLLOWING A SIGNIFICANT RAINFALL EVENT A DISCHARGE EXCEEDING 100 NTU.

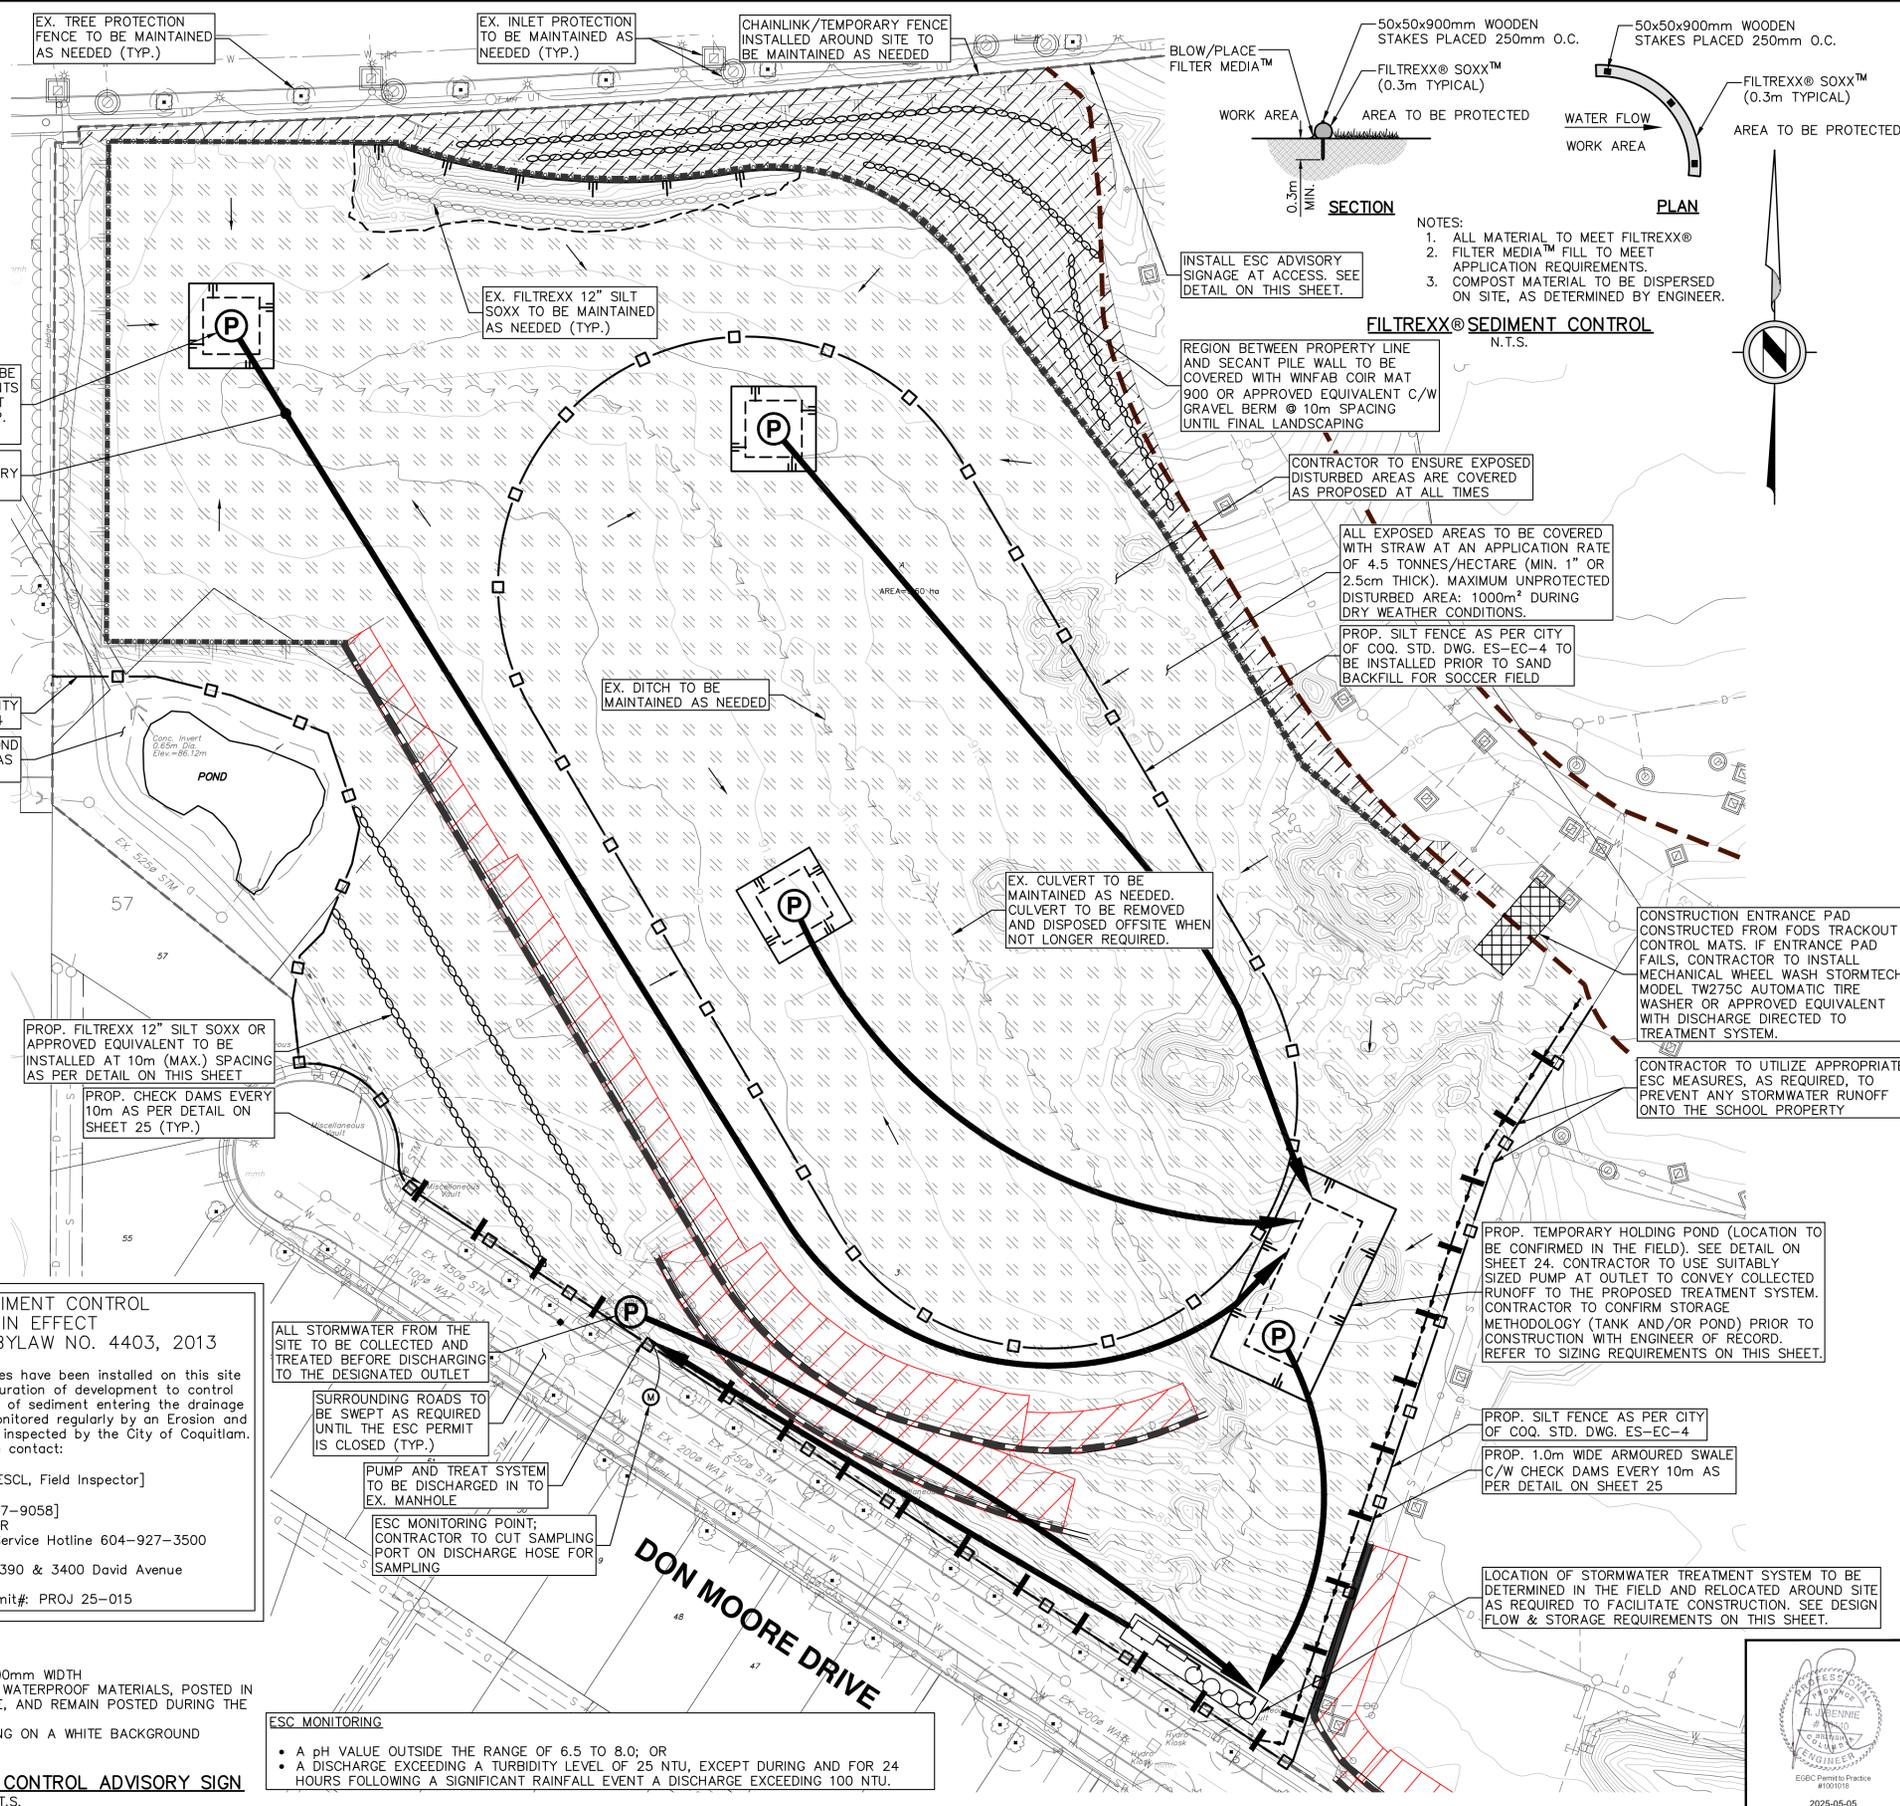

Edge of pavement	Hydrant	Sanitary service	Hydro Guy Wire
Watermain and valve	Water air valve	Sanitary cleanout	Hydro Kiosk
Drainage sewer, MH	Water blowoff	Utility pole (joint pole)	Vegetation Conifer
Drainage ditch	Water service	Utility pole with light	Vegetation Deciduous
Sanitary sewer, MH	Catch basin, top inlet	Streetlight, davit	Vegetation Shrub
Sanitary forcemain	Catch basin, side inlet	Survey Traverse Hub	Survey Iron Pin
Gasmain and valve	Catch basin, round	Comb signal pole	Survey Lead Plug
Hydro duct, MH	Drainage service	Traffic signal pole	Survey Monument
Telephone duct, MH	Drainage cleanout	Junction box	

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Design by: ASB Date: MAY, 2024

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Approved by: RJB Date: MAY, 2024

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ACCEPTED FOR CONSTRUCTION
 Date: _____
 Manager of Development Servicing

Coquitlam
 Engineering & Public Works
 3000 Guildford Way, Coquitlam, B.C. V3B 7N2

Scale horiz. 1:500 Scale vert. N/A

Sheet of **23 of 26**

Eng. Project No. **PROJ 25-015**

Project: **BURKE MOUNTAIN ATHLETIC PARK**

Description: **EROSION & SEDIMENT CONTROL STAGE 1 - EARTHWORKS**

File: 18-264A

LEGEND

- SILT FENCE
- LOCK-BLOCK RETAINING WALL
- SECANT PILE RETAINING WALL
- INLET PROTECTION AT EX. CATCH BASINS AND LAWN BASINS
- INLET PROTECTION AT PROP. CATCH BASINS AND LAWN BASINS
- ESC MONITORING POINT
- PROPOSED SUMP PUMP
- OVERLAND FLOW DIRECTION
- CONSTRUCTION ENTRANCE PAD
- COIR MAT
- PROPOSED STRAW / HAY (4.5 TONNES/HECTARE)
- FILTREXX 12" SILT SOXX

NOTES: STAGE 2 - SITE UTILITIES

SEDIMENT & EROSION CONTROL DURING THE CONSTRUCTION OF THE UNDERGROUND UTILITY PHASE IS TO BE COMPLETED BY THE CONTRACTOR AS FOLLOWS:

- AFTER INSTALLATION OF THE CB'S, "FLEXSTORM" OR APPROVED EQUIVALENT CB SURROUNDS SHALL BE INSTALLED AROUND THE CB TO PREVENT SILT FROM ENTERING THE STORM SEWER SYSTEM. CLEAN AND REPLACE AS NECESSARY.
- AFTER INSTALLATION OF SEDIMENT CONTROL FACILITIES, ESC MONITOR SHALL INSPECT THE SILTATION CONTROL FACILITIES TO ENSURE PROPER OPERATIONS. ESC MONITOR SHALL CONDUCT REGULAR INSPECTIONS OF THE SILTATION CONTROL FACILITIES. STOCKPILES OF EXCAVATED MATERIAL ARE TO BE PROTECTED WITH 6mil-THICK POLYETHYLENE SHEETING (OR SIMILAR) AND SURROUNDED BY SILT FENCE TO MINIMIZE SOIL EROSION DUE TO RAINFALL EVENTS. SEE DETAIL ON SHEET 22.

NOTE
PROP. TOTAL PRE-TREATMENT DETENTION VOLUME TO BE PROVIDED AS A COMBINATION OF TANKS AND PONDS



NOTE
ESC ADVISORY SIGN TO BE MAINTAINED AS REQUIRED UNTIL THE ESC PERMIT IS CLOSED.

NOTE
1. CONTRACTOR TO MAINTAIN ALL INSTALLED ESC FACILITIES AS NEEDED.
2. ESC FACILITIES TO BE ONLY REMOVED UPON ESC SUPERVISOR'S APPROVAL.


CONTRACTOR TO INSTALL FILTREXX 12" SILT SOXX OR APPROVED EQUIVALENT FOR INLET PROTECTION OF TRENCH DRAINS (TYP.). SEE DETAIL ON SHEET 23.

SILT FENCE INSTALLED IN STAGE 1 TO BE MAINTAINED AS NEEDED

ACHIEVED POND VOLUMES:
TOTAL VOLUME = 565.06m³
FREEBOARD VOLUME = 127.12m³
DEAD STORAGE VOLUME = 35.57m³
LIVE STORAGE VOLUME = 402.37m³

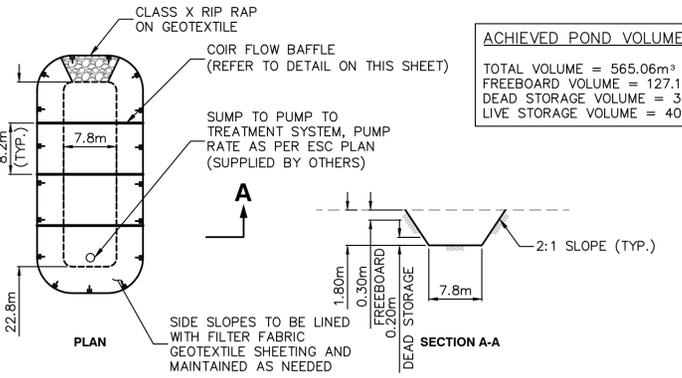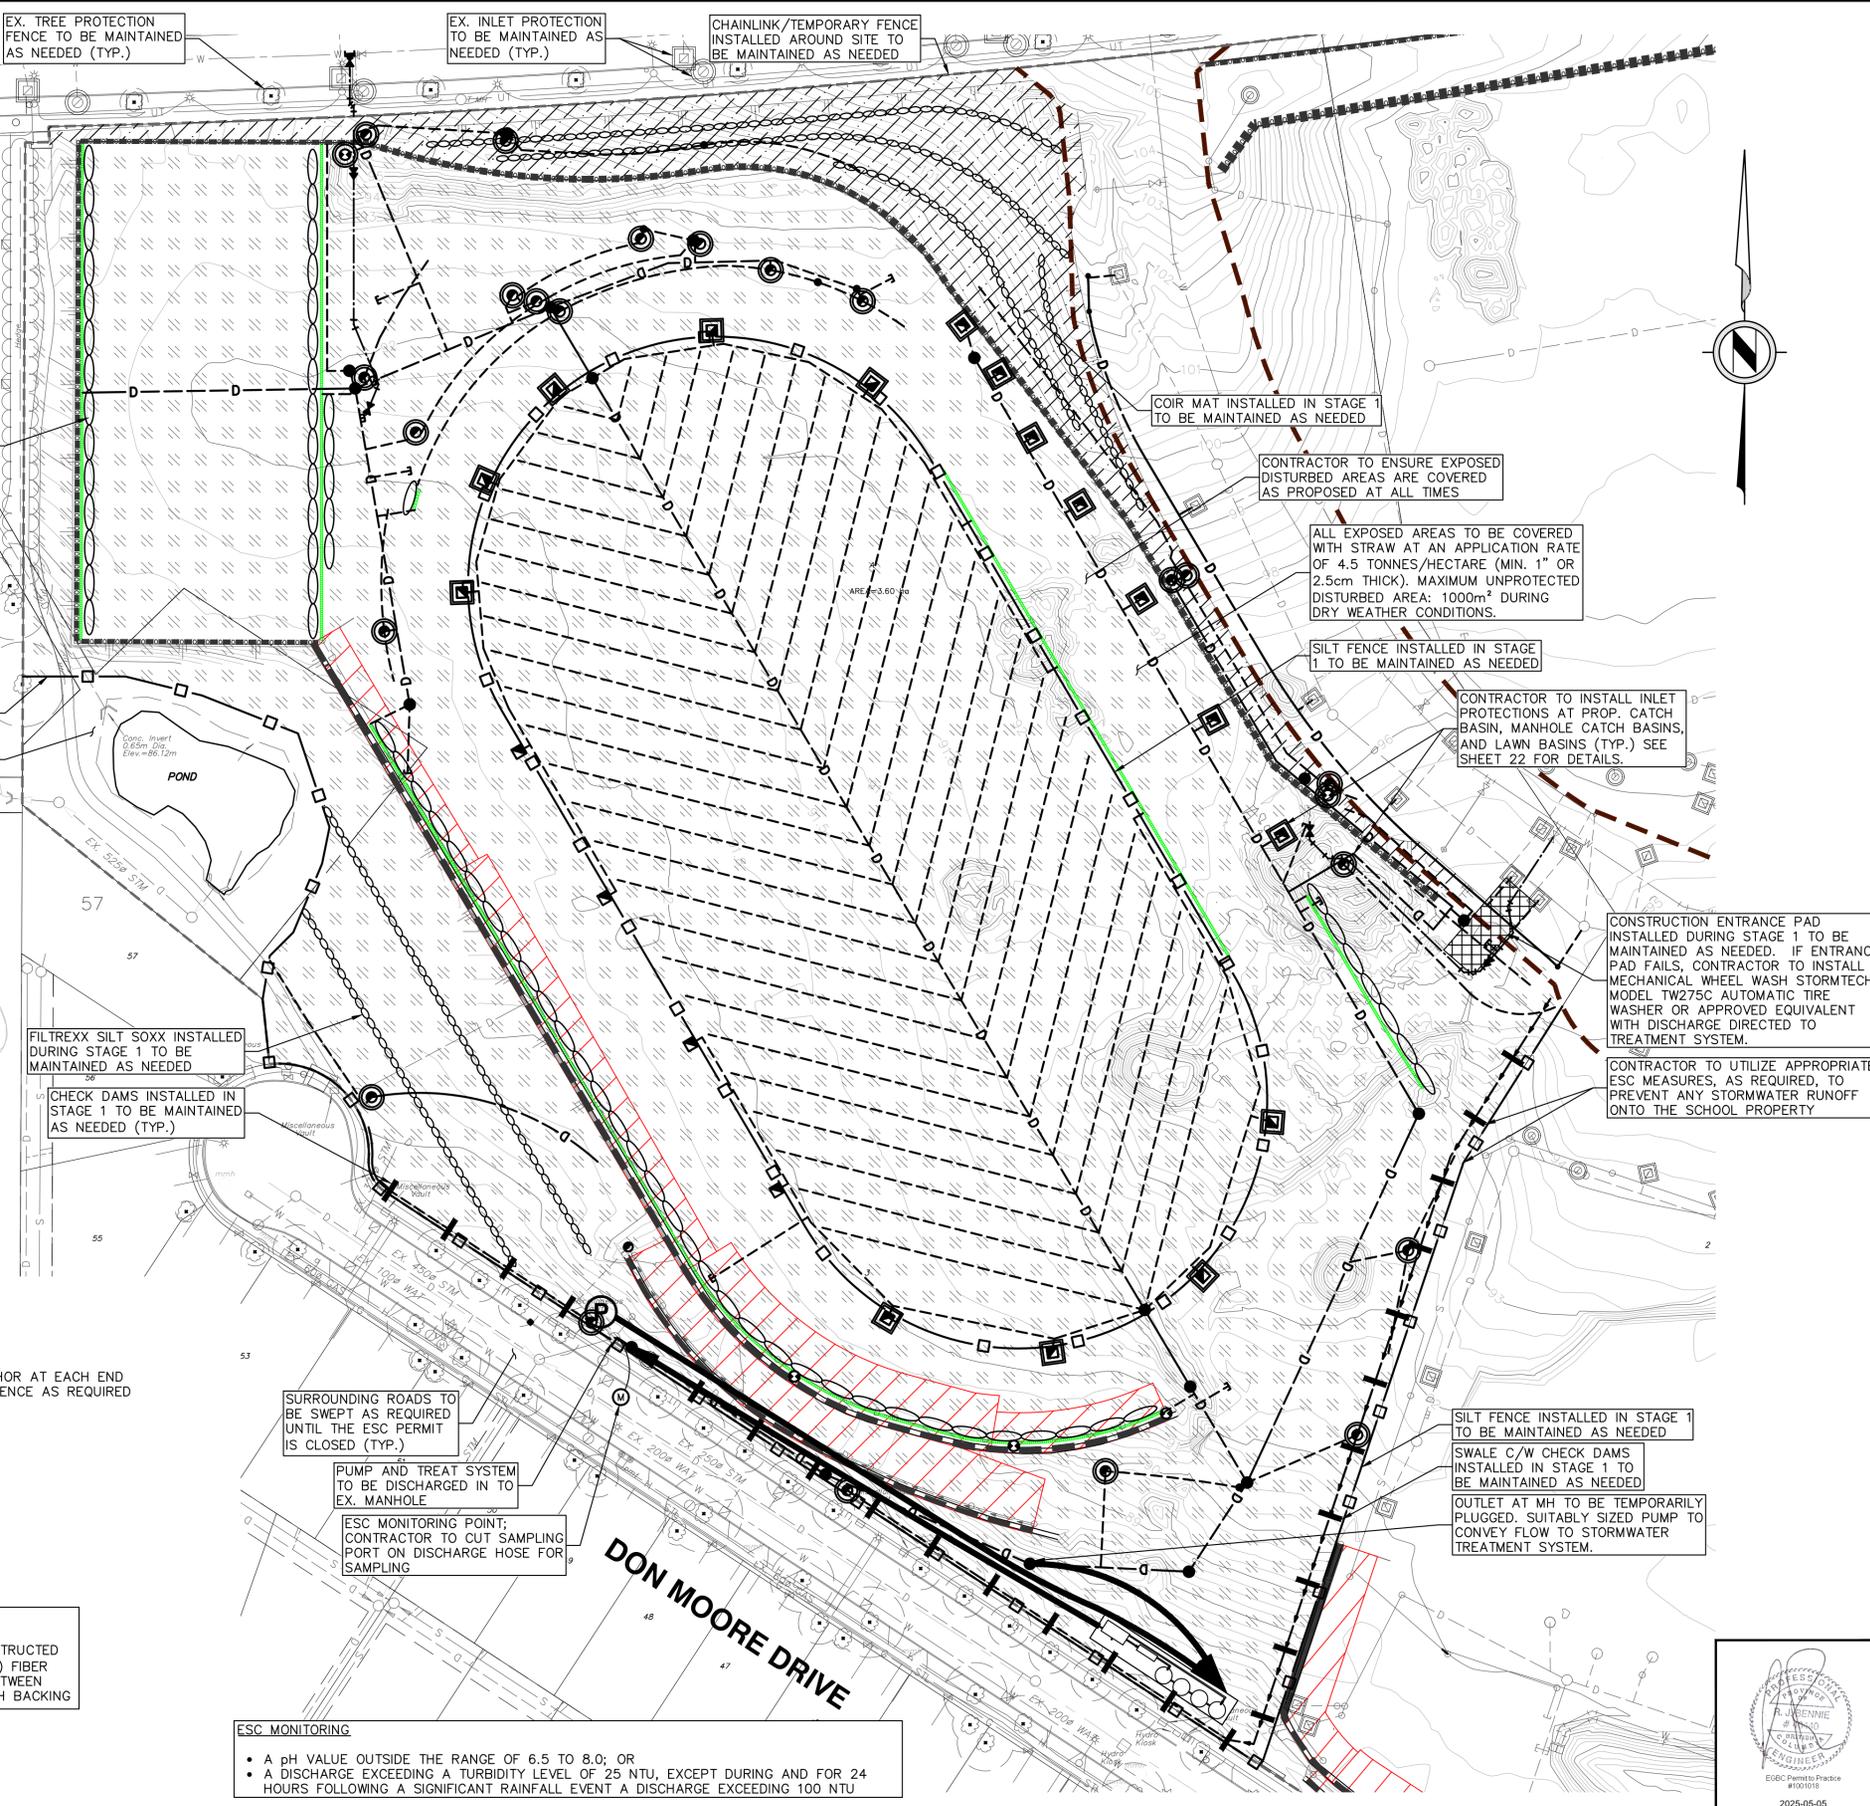

TEMPORARY HOLDING POND
N.T.S.

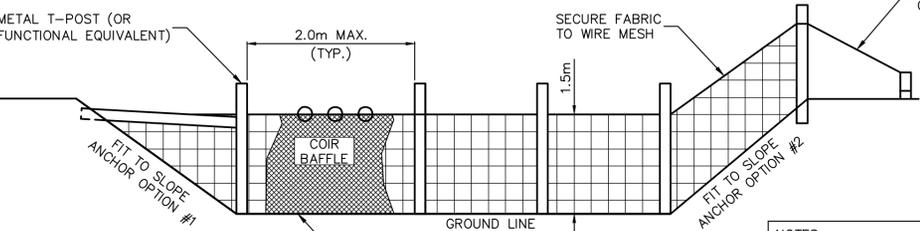

FLOW BAFFLE DETAIL
N.T.S.

NOTES:
BAFFLES SHALL BE CONSTRUCTED OF 100% COCONUT (COIR) FIBER MATERIAL SUPPORTED BETWEEN POSTS WITH A WIRE MESH BACKING

ESC MONITORING

- A pH VALUE OUTSIDE THE RANGE OF 6.5 TO 8.0; OR
- A DISCHARGE EXCEEDING A TURBIDITY LEVEL OF 25 NTU, EXCEPT DURING AND FOR 24 HOURS FOLLOWING A SIGNIFICANT RAINFALL EVENT A DISCHARGE EXCEEDING 100 NTU

MAY 05 2025 11:47am MA_SUR-LD\18-2644\DWG\ON SITE - PRODUCTION\18-2644 - ON SITE CONSTRUCTION ESC - STAGE 2.dwg/24 ESC - STAGE 2

Edge of pavement	Hydrant	Sanitary service	Hydro Guy Wire
Watermain and valve	Water air valve	Sanitary cleanout	Hydro Kiosk
Drainage sewer, MH	Water blowoff	Utility pole (joint pole)	Vegetation Conifer
Drainage ditch	Water service	Utility pole with light	Vegetation Deciduous
Sanitary sewer, MH	Catch basin, top inlet	Streetlight, davit	Vegetation Shrub
Sanitary forcemain	Catch basin, side inlet	Streetlight, post top	Survey Traverse Hub
Gasmain and valve	Catch basin, round	Comb signal pole	Survey Iron Pin
Hydro duct, MH	Drainage service	Traffic signal pole	Survey Lead Plug
Telephone duct, MH	Drainage cleanout	Junction box	Survey Monument

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Design by: ASB Date: MAY, 2024

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Approved by: RJB Date: MAY, 2024

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ACCEPTED FOR CONSTRUCTION
Date: _____

Manager of Development Servicing

Coquitlam
Engineering & Public Works
3000 Guildford Way, Coquitlam, B.C. V3B 7N2

Scale horiz. 1:500 Scale vert. N/A

Sheet of **24 of 26**

Eng. Project No. **PROJ 25-015**

Project: **BURKE MOUNTAIN ATHLETIC PARK**

Description: **EROSION & SEDIMENT CONTROL STAGE 2 - SITE UTILITIES**

File: 18-2644

0 5 1:500 25m

MAY 05 2025 11:47am MA_SUR-LD\18-2644\DWG\ON SITE\CONSTRUCTION ESC - STAGE 3.dwg/25 ESC - STAGE 3 - ABROR

LEGEND

SILT FENCE	
LOCK-BLOCK RETAINING WALL	
SECANT PILE RETAINING WALL	
INLET PROTECTION AT EX. CATCH BASINS AND LAWN BASINS	
INLET PROTECTION AT PROP. CATCH BASINS AND LAWN BASINS	
ESC MONITORING POINT	
PROPOSED SUMP PUMP	
OVERLAND FLOW DIRECTION	
CONSTRUCTION ENTRANCE PAD	
COIR MAT	
PROPOSED STRAW /HAY (4.5 TONNES/HECTARE)	

NOTES: STAGE 3 – SURFACE WORKS

SEDIMENT & EROSION CONTROL DURING THE CONSTRUCTION OF THE ROADS AND LANDSCAPING PHASE IS TO BE COMPLETED BY THE CONTRACTOR AS FOLLOWS:

1. THE CONTRACTOR SHALL INSPECT ALL SEDIMENT CONTROL FACILITIES ONCE EVERY 7 DAYS AND PRIOR TO THE ONSET OF A SIGNIFICANT RAINFALL.
2. CATCH BASINS SHALL BE CLEANED A MINIMUM OF ONCE EVERY 7 DAYS OR AS NEEDED TO MAINTAIN FUNCTIONALITY AS DIRECTED BY ESC MONITOR OR SUPERVISOR.
3. ANY IRREGULARITIES SHALL BE REPORTED TO THE ESC MONITOR.
4. ALL SEDIMENT CONTROL FACILITIES SHALL REMAIN IN PLACE UNTIL 90% OF THE SITE WORKS HAVE BEEN COMPLETED. REMOVAL CAN TAKE PLACE ONLY ON THE APPROVAL BY THE ESC MONITOR OR ONCE THE ESC PERMIT FOR THE SITE IS CLOSED.

DE-COMMISSIONING

1. DE-COMMISSIONING OF ALL SEDIMENT CONTROL FACILITIES: ON COMPLETION OF ALL CONSTRUCTION ACTIVITIES AND BOULEVARD LANDSCAPING ESC SUPERVISOR WILL REVIEW SITE AND MAKE RECOMMENDATION ON ESC FACILITY DECOMMISSIONING. NO DECOMMISSIONING IS TO COMMENCE UNTIL WRITTEN AUTHORIZATION FROM THE ESC SUPERVISOR HAS BEEN ISSUED.
2. ALL SILT FENCES, FILTREXX SOXX, AND FLEXSTORM BAGS SHALL BE REMOVED AFTER CONSTRUCTION WORKS HAVE BEEN COMPLETED.
3. ANY POINTS OF ENTRY OTHER THAN THE PROPOSED DRIVEWAYS SHALL BE REMOVED AND AREA REINSTATED AS PER THE DESIGN DRAWINGS AFTER CONSTRUCTION WORKS HAVE BEEN COMPLETED.

THE ENGINEER OF RECORD, OR HIS AGENT, WILL MONITOR THE CONDITIONS AT THE SITE AND PROVIDE ADDITIONAL DIRECTION AS REQUIRED. THIS DIRECTION MAY INCLUDE ADDITIONAL SEDIMENT AND EROSION CONTROL MEASURES OR ACTIONS, AS REQUIRED. SHOULD THESE DIRECTIONS NOT BE IMPLEMENTED IN A TIMELY MANNER, WRITTEN NOTICE OF NON-CONFORMANCE WILL BE ISSUED. SHOULD THE SITUATION NOT BE RECTIFIED, THE ENGINEER OF RECORD WILL INITIATE ACTION AT THE COST OF THE CONTRACTOR.

NOTE


PROP. TOTAL PRE-TREATMENT DETENTION VOLUME TO BE PROVIDED AS A COMBINATION OF TANKS AND PONDS

NOTE

ESC ADVISORY SIGN TO BE MAINTAINED AS REQUIRED UNTIL THE ESC PERMIT IS CLOSED.

NOTE

1. CONTRACTOR TO MAINTAIN ALL INSTALLED ESC FACILITIES AS NEEDED.
2. ESC FACILITIES TO BE ONLY REMOVED UPON ESC SUPERVISOR'S APPROVAL.

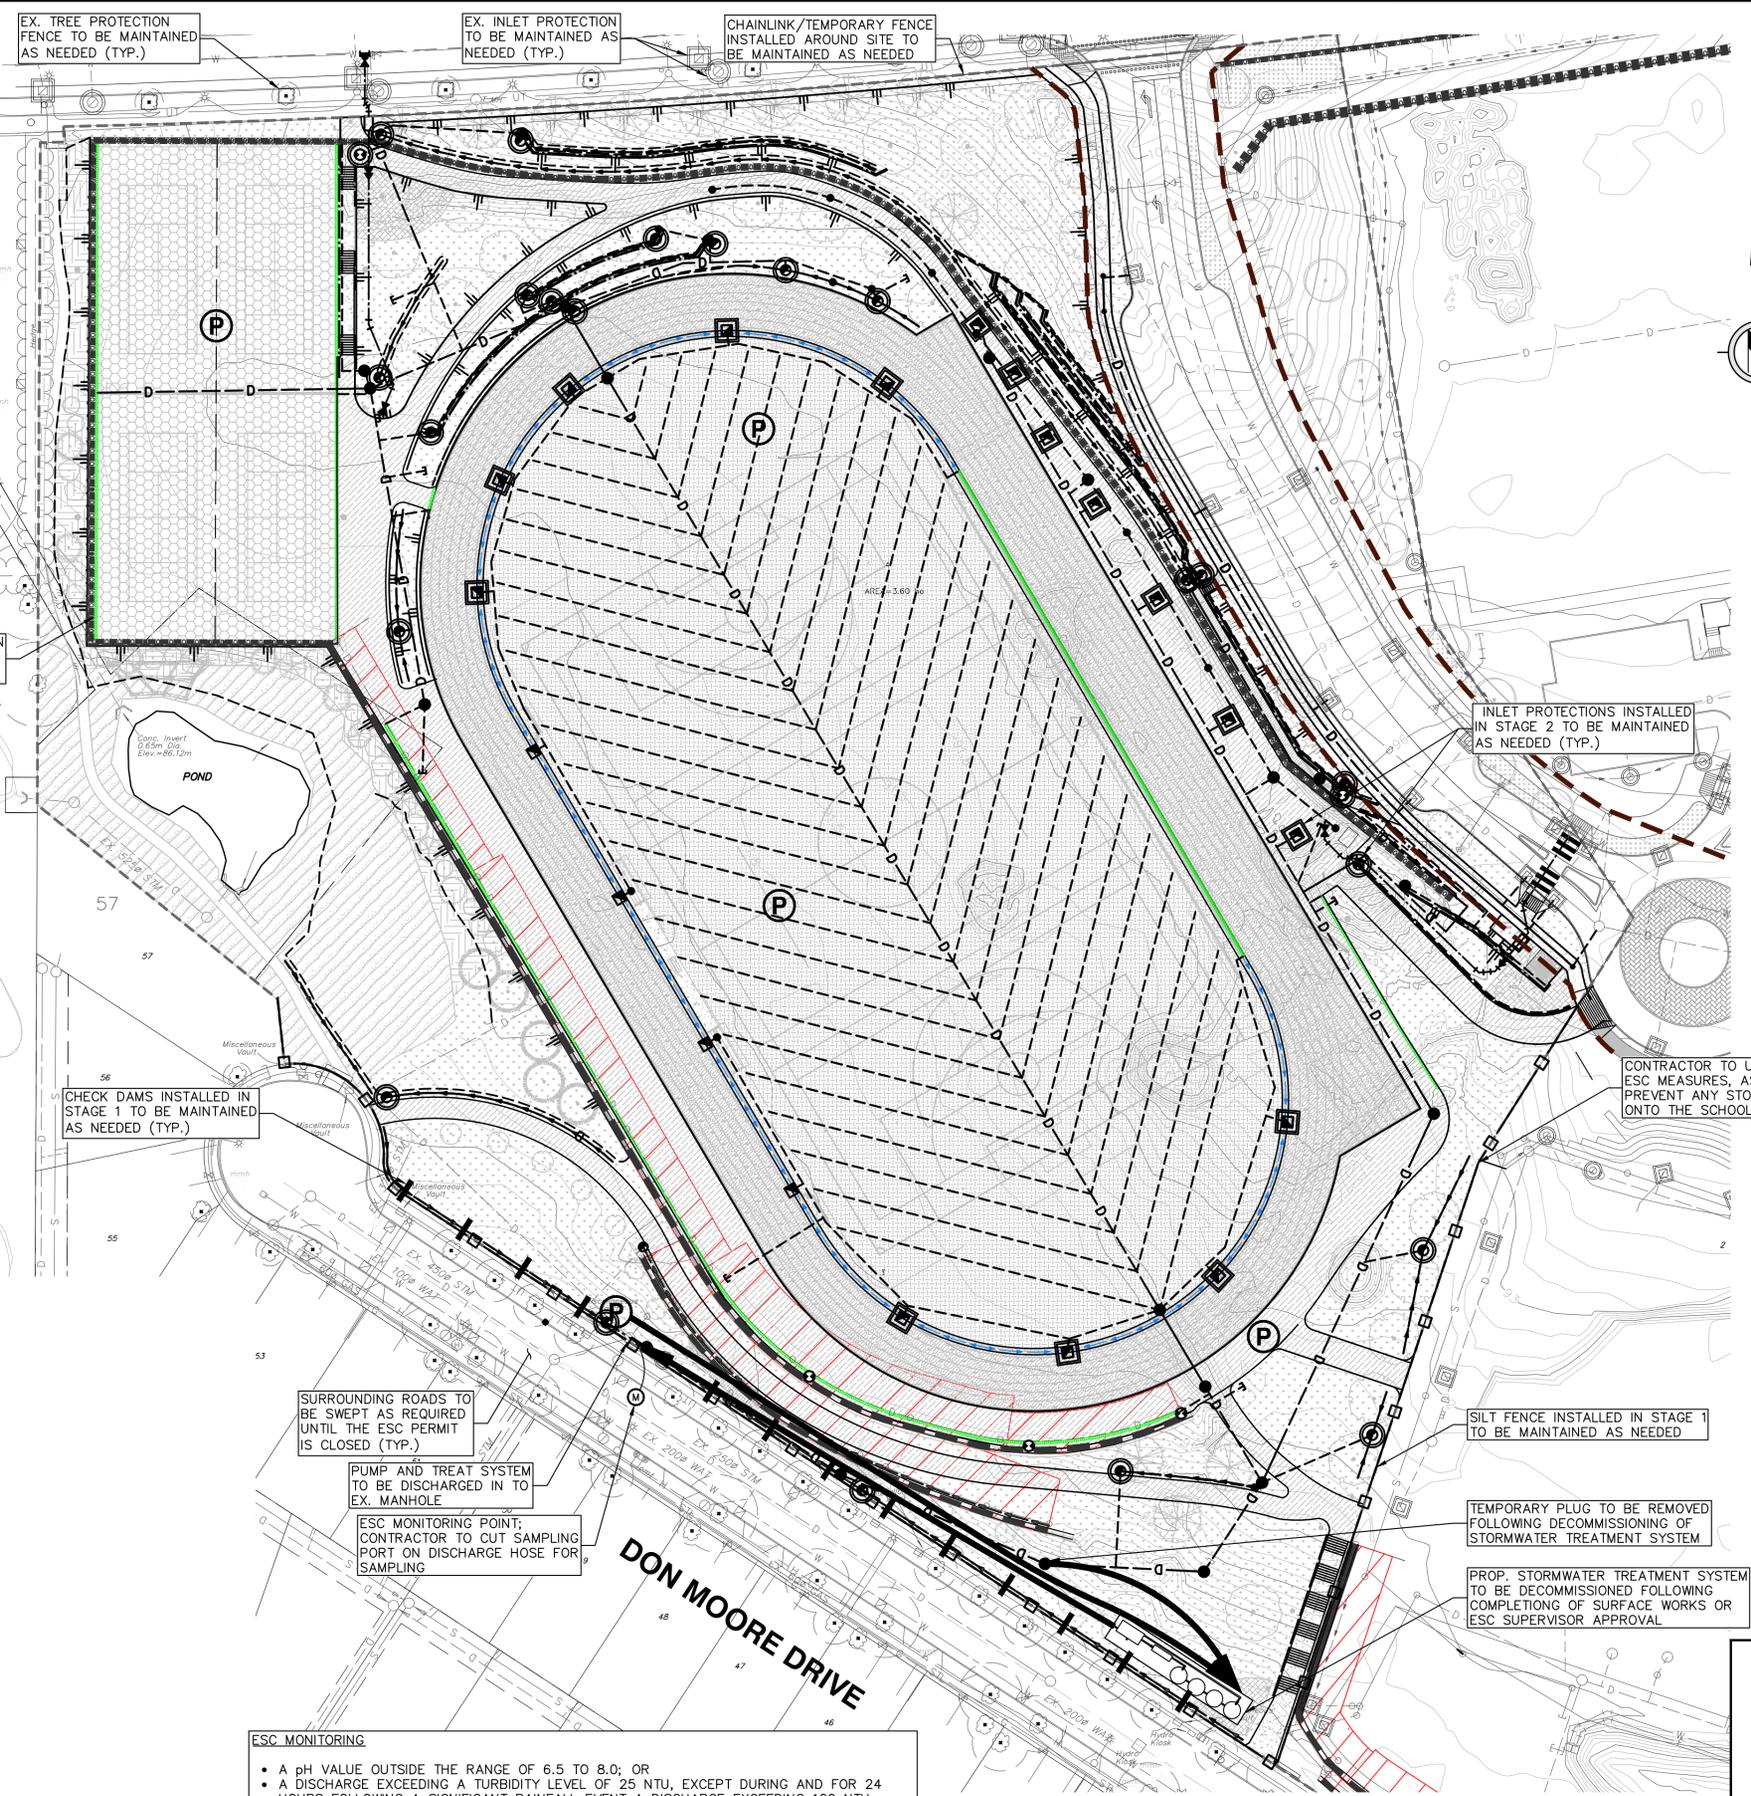

TRENCH DRAIN INLET PROTECTION INSTALLED IN STAGE 2 TO BE MAINTAINED AS NEEDED (TYP.)

CHECK DAMS INSTALLED IN STAGE 1 TO BE MAINTAINED AS NEEDED (TYP.)

SURROUNDING ROADS TO BE SWEEPED AS REQUIRED UNTIL THE ESC PERMIT IS CLOSED (TYP.)

PUMP AND TREAT SYSTEM TO BE DISCHARGED IN TO EX. MANHOLE

ESC MONITORING POINT; CONTRACTOR TO CUT SAMPLING PORT ON DISCHARGE HOSE FOR SAMPLING


INLET PROTECTIONS INSTALLED IN STAGE 2 TO BE MAINTAINED AS NEEDED (TYP.)

CONTRACTOR TO UTILIZE APPROPRIATE ESC MEASURES, AS REQUIRED, TO PREVENT ANY STORMWATER RUNOFF ONTO THE SCHOOL PROPERTY


SILT FENCE INSTALLED IN STAGE 1 TO BE MAINTAINED AS NEEDED

TEMPORARY PLUG TO BE REMOVED FOLLOWING DECOMMISSIONING OF STORMWATER TREATMENT SYSTEM

PROP. STORMWATER TREATMENT SYSTEM TO BE DECOMMISSIONED FOLLOWING COMPLETION OF SURFACE WORKS OR ESC SUPERVISOR APPROVAL

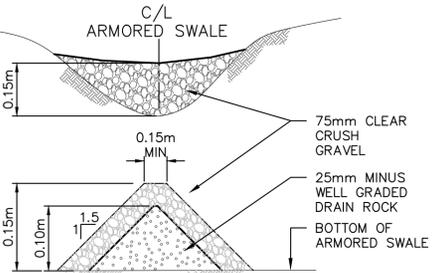

GRAVEL CHECK DAM DETAIL
N.T.S.

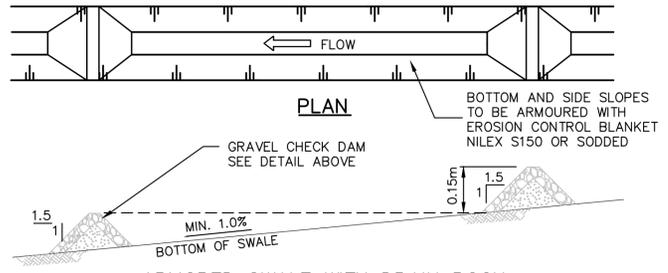

ARMORED SWALE WITH DRAIN ROCK BERM SECTION VIEW
N.T.S.

ESC MONITORING

- A pH VALUE OUTSIDE THE RANGE OF 6.5 TO 8.0; OR
- A DISCHARGE EXCEEDING A TURBIDITY LEVEL OF 25 NTU, EXCEPT DURING AND FOR 24 HOURS FOLLOWING A SIGNIFICANT RAINFALL EVENT A DISCHARGE EXCEEDING 100 NTU

Edge of pavement	Hydrant	Sanitary service	Hydro Guy Wire
Watermain and valve	Water air valve	Sanitary cleanout	Hydro Kiosk
Drainage sewer, MH	Water blowoff	Utility pole (joint pole)	Vegetation Conifer
Drainage ditch	Water service	Utility pole with light	Vegetation Deciduous
Sanitary sewer, MH	Catch basin, top inlet	Streetlight, joint	Vegetation Shrub
Sanitary forcemain	Catch basin, side inlet	Streetlight, post top	Survey Traverse Hub
Gasmain and valve	Catch basin, round	Comb signal pole	Survey Iron Pin
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Telephone duct, MH	Drainage cleanout	Junction box	Survey Monument

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ACCEPTED FOR CONSTRUCTION

Date: _____

Manager of Development Servicing

Coquitlam

Engineering & Public Works

3000 Guildford Way, Coquitlam, B.C. V3B 7N2

Scale horiz.	1:500	Scale vert.	N/A
Sheet of	25 of 26		
Eng. Project No.	PROJ 25-015		

Project: **BURKE MOUNTAIN ATHLETIC PARK**

Description: **EROSION & SEDIMENT CONTROL STAGE 3 - SURFACE WORKS**

File: 18-2644

PART 1 – EXTENT OF WORK

1.1. CIVIL WORKS

- 1.1.1. THIS CONTRACT IS FOR THE SUPPLY, INSTALLATION AND MAINTENANCE OF:
 - ALL EROSION AND SILTATION CONTROL WORKS AS DETAILED IN THE CIVIL DRAWINGS, AND/OR ANY OTHER TEMPORARY FACILITIES FOUND NECESSARY DURING CONSTRUCTION SUCH AS TEMPORARY SILTATION PONDS OR MECHANICAL TREATMENT FACILITIES;
 - ALL CLEARING AND GRUBBING AS REQUIRED FOR CONSTRUCTION;
 - ALL EARTHWORKS, GRADING, RETAINING WALLS IF ANY, AND SURFACE RESTORATION IN ACCORDANCE WITH CONTRACT DRAWINGS;
 - THE SUPPLY AND INSTALLATION OF STORM SEWERS, INCLUDING INFILTRATION ROCK PIT, FRENCH DRAIN, STORM BUILDING CONNECTIONS, APPURTENANCES, CATCH BASINS, LAWN BASINS, OIL-WATER SEPARATORS AND INSTALLATION OF DRY WELL, AS WELL AS REMOVAL AND DISPOSAL OFFSITE OF THE EXISTING STORM SYSTEM WITHIN THE SUBJECT AREA.
 - THE SUPPLY AND INSTALLATION OF SANITARY SEWERS, INCLUDING TIE-INS TO SANITARY SERVICE CONNECTION, SANITARY BUILDING CONNECTIONS, AND APPURTENANCES.
 - THE SUPPLY AND INSTALLATION OF THE FIRE AND DOMESTIC WATER MAIN AND APPURTENANCES, WITH REMOVAL AND DISPOSAL OFFSITE OF SECTION OF THE EXISTING WATER MAIN .
 - CONSTRUCTION OF PROPOSED EARTHWORKS, STORM SERVICING, RETAINING WALLS AND ASSOCIATED DRAINAGE WORKS, AND RESTORATION OF DISTURBED PAVEMENT, CURBING, WALKWAYS, AND BOULEVARD.
 - THE SUPPLY AND CONSTRUCTION OF ALL CIVIL WORKS FOR SITE & ROADWAY LIGHTING, TRAFFIC SIGNALS, BC HYDRO, TELUS AND CABLEVISION UNDERGROUND WIRING SYSTEMS (DETAILS PROVIDED IN DRAWINGS BY THE ELECTRICAL ENGINEER).
- 1.1.2. THE CONTRACTOR SHALL MAKE ALLOWANCES FOR PROVIDING THE NECESSARY CAPS AND TEST POINTS FOR THE WATERMANS, STORM SEWERS, AND SANITARY SEWERS. THESE CAPS OR TEST POINTS ARE NOT NECESSARILY SHOWN ON THE DRAWINGS.
- 1.1.3. IT IS RECOMMENDED THAT THE CONTRACTOR VISIT THE SITE PRIOR TO BIDDING AND TO PERFORM WHATEVER INVESTIGATIONS DEEMED NECESSARY TO ENSURE A CLEAR UNDERSTANDING OF THE SITE CONDITIONS, SCOPE OF THE WORKS AND LIMITATION OF THIS CONTRACT.
- 1.1.4. THE CONTRACTOR MAY BE REQUIRED TO PROVIDE FLAG PERSON(S) TO MANAGE TRAFFIC DURING CONSTRUCTION. ANTICIPATED COSTS FOR TRAFFIC CONTROL, IF ANY, TO BE INCLUDED IN CONTRACT PRICE.

PART 2 – PRODUCTS

2.1. PRODUCT APPROVALS

- 2.1.1. THE CONTRACTOR IS TO SUBMIT SPECIFICATIONS FOR ANY PRODUCTS PROPOSED FOR USE IN CONSTRUCTION AS AN APPROVED ALTERNATIVE TO THE PRODUCTS SPECIFIED ON THE CONTRACT DRAWINGS TO THE ENGINEER OF RECORD FOR APPROVAL PRIOR TO USE IN CONSTRUCTION.

2.2. CITY SPECIFICATIONS

- 2.2.1. ALL WORK MUST BE DONE IN ACCORDANCE WITH THE STANDARDS AND SPECIFICATIONS OF THE CITY OF COQUITLAM AND THE MASTER MUNICIPAL CONSTRUCTION DOCUMENTS. IT SHALL BE THE RESPONSIBILITY OF THE CONTRACTOR TO OBTAIN, FOR HIMSELF, A CURRENT COPY OF THESE STANDARDS AND SPECIFICATIONS.

PART 3 – EXECUTION

3.1. DRAWINGS

- 3.1.1. THE CONTRACTOR IS TO COMPLETE THE WORK AS PER THE ONSITE CIVIL DRAWINGS, INCLUDING ALL SPECIFICATIONS CONTAINED THEREIN.

3.2. BUILDING CODE

- 3.2.1. ALL WORK MUST BE DONE IN ACCORDANCE WITH THE STANDARDS AND SPECIFICATIONS OF THE BC BUILDING CODE 2018. IT SHALL BE THE RESPONSIBILITY OF THE CONTRACTOR TO OBTAIN, FOR HIMSELF, A CURRENT COPY OF THESE SPECIFICATIONS.
- 3.2.2. THE CONTRACTOR TO PROVIDE COPIES OF ALL INSPECTION REPORTS FROM THE CITY OF COQUITLAM PLUMBING INSPECTOR TO THE ENGINEER.

3.3. CONSTRUCTION CONTROL LAYOUT – BY CONTRACTOR

- 3.3.1. THE CONTRACTOR WILL BE RESPONSIBLE TO SUPPLY HIS OWN CONSTRUCTION CONTROL LAYOUT.

3.4. SILTATION CONTROL

- 3.4.1. EROSION AND SEDIMENT CONTROL (ESC) DRAWINGS ARE TO BE INCLUDED AS PART OF THE BUILDING PERMIT DESIGN PACKAGE. THE CONTRACTOR WILL BE REQUIRED, AS A MINIMUM, TO COMPLY WITH THE INFORMATION SHOWN ON THESE PLANS, PARTICULARLY WITH REGARD TO TIMING AND IMPLEMENTATION.
- 3.4.2. WHERE THE OWNER IS REQUIRED TO RETAIN AN ESC SUPERVISOR AND/OR ESC MONITOR, THEN PERIODIC INSPECTIONS OF THE PROJECT WILL BE CARRIED OUT TO ASSESS THE CONTRACTOR'S EFFECTIVE IMPLEMENTATION OF THE ESC STRATEGIES, AND TO TAKE WATER QUALITY SAMPLES FOR TESTING (EITHER NTU OR TSS TESTS). THE ESC MONITOR WILL ALSO NOTIFY THE CONTRACTOR OF THE TEST RESULTS, AND WHERE NECESSARY MAKE RECOMMENDATIONS ON ADDITIONAL STRATEGIES NECESSARY, OR IDENTIFY CURRENT ACTIVITIES THAT NEGATE THE EFFECTIVENESS OF THE ESC PLAN, IN ORDER TO BRING THE WATER QUALITY TEST RESULTS INTO COMPLIANCE. IT IS THE RESPONSIBILITY OF THE CONTRACTOR TO TAKE IMMEDIATE ACTION TO CORRECT THESE MATTERS TO THE SATISFACTION OF THE ESC MONITOR AND/OR ESC SUPERVISOR.
- 3.4.3. SOURCE CONTROL STRATEGIES ARE TO BE THE PRIMARY MEANS FOR CONTROLLING EROSION AND THE TRANSPORTATION OF SEDIMENT ON THE SITE. PUMPING OR DIRECT ROUTING OF HEAVILY SILT-LADEN WATERS DIRECTLY INTO THE NEW AND/OR EXISTING STORM SYSTEM IS NOT ACCEPTABLE. NON-COMPLIANCE WITH THE IMPLEMENTATION OF THE REQUIRED STRATEGIES BY THE CONTRACTOR MAY RESULT IN THE NEED FOR ADDITIONAL ESC STRATEGIES (EITHER MECHANICAL OR CHEMICAL, AS NECESSARY) TO BE IMPLEMENTED AT THE COST OF THE CONTRACTOR.
- 3.4.4. DURING THE CONSTRUCTION OF THE WORKS, THE CONTRACTOR SHALL COMPLY WITH ALL REGULATORY AUTHORITIES, MINISTRY OF ENVIRONMENT, DEPARTMENT OF FISHERIES AND OCEANS CANADA, AND LOCAL MUNICIPAL BYLAWS FOR EROSION AND SEDIMENT CONTROL, AND THE PROTECTION OF FISH AND WILDLIFE, AND SHALL BE RESPONSIBLE FOR ALL COSTS IN COMPLYING WITH THESE REQUIREMENTS.
- 3.4.5. THE CONTRACTOR SHALL TAKE ADEQUATE STEPS, INCLUDING BUT NOT LIMITED TO THE REQUIREMENTS SHOWN ON THE ESC PLANS (WHICH TYPICALLY INCLUDE INSTALLATION OF SILT FENCES, APPLICATION OF MULCHES, PROTECTION OF CATCH BASIN INLETS, COVERING OF STOCKPILES, TEMPORARY SEDIMENT CONTROL PONDS, DITCHING OR ANY OTHER MEASURES) AS MAY BE NECESSARY TO PREVENT SILT AND OTHER DELETERIOUS MATERIALS FROM THE WORKS ENTERING THE STORM DRAINAGE SYSTEM AND RECEIVING WATERCOURSE.
- 3.4.6. THE CONTRACTOR SHALL BE RESPONSIBLE FOR ALL REQUIRED MAINTENANCE, INCLUDING REMOVAL OF SILT FROM SILTATION CONTROL STRUCTURES, AND REPAIRS AS REQUIRED TO ENSURE PROPER OPERATION OF THE SILTATION CONTROL SYSTEM DURING THE CONSTRUCTION OF THE WORKS, UNTIL THE PROJECT IS PLACED ON MAINTENANCE.

- 3.4.7. THE CONTRACTOR SHALL BE RESPONSIBLE TO ENSURE THAT RUNOFF FROM THE SITE CONFORMS TO DFO LAND DEVELOPMENT GUIDELINES AND THE REQUIREMENTS OF THE LOCAL ESC BYLAW, SUCH AS:
 - "RUNOFF WATER FROM THE DEVELOPMENT SITE SHOULD CONTAIN LESS THAN 25MG/LITRE OF SUSPENDED SOLIDS ABOVE THE BACKGROUND SUSPENDED SOLIDS LEVELS OF THE RECEIVING WATERS DURING NORMAL DRY WEATHER OPERATION AND LESS THAN 75MG/LITRE OF SUSPENDED SOLIDS ABOVE THE BACKGROUND LEVELS DURING DESIGN STORM EVENTS."
 - "NO PERSON SHALL CAUSE, OR PERMIT ANOTHER PERSON TO CAUSE, SEDIMENT OR SEDIMENT-LADEN WATER TO BE DISCHARGED, EITHER DIRECTLY OR INDIRECTLY, INTO THE CITY DRAINAGE SYSTEM GREATER THAN 25TSS."
- 3.4.8. THE COST OF SUCH WORKS SHALL BE INCLUDED IN THE PRICE BID FOR SILTATION FACILITIES. NO EXTRAS WILL BE PAID RELATING TO EROSION AND SEDIMENT CONTROL. THE COST OF SUCH WORKS SHALL BE INCLUDED IN THE PRICE BID FOR EROSION & SILTATION CONTROL FACILITIES.

3.5. TREE PRESERVATION, REMOVAL, RELOCATION & REPLACEMENT

- 3.5.1. THE CONTRACTOR SHALL TAKE ADEQUATE STEPS NECESSARY TO ENSURE PRESERVATION OF THE TREES TO BE RETAINED, AND SHALL TAKE EXTRA PRECAUTION WHEN WORKING NEAR OR AROUND TREES.
- 3.5.2. REMOVAL OF TREES FROM THIS SITE IS GOVERNED BY THE LOCAL MUNICIPAL TREE PRESERVATION, REMOVAL AND REPLACEMENT BYLAW. TREE REMOVAL OR PRUNING IS STRICTLY PROHIBITED WITHOUT THE EXPRESS APPROVAL OF THE OWNER.

3.6. TOPSOIL AND GRASS SEEDING

- 3.6.1. TOPSOIL AND GRASS SEEDING OF AREAS DISTURBED DURING CONSTRUCTION IS TO BE COMPLETED BY THE CONTRACTOR. TOPSOIL MAY BE NATIVE TOPSOIL OR IMPORTED TOPSOIL MEETING THE CITY OF COQUITLAM'S SUPPLEMENTARY SPECIFICATIONS TO THE MMCD.

3.7. EXISTING CATCH BASINS & STORM INLETS

- 3.7.1. ALL EXISTING CATCH BASIN GRATES AND STORM SEWER INLETS IN THE IMMEDIATE VICINITY OF THE PROJECT SITE ARE TO BE EFFECTIVELY PROTECTED AGAINST ENTRY OF SILT-LADEN WATERS.

3.8. RELATED WORK IN THE VICINITY OF FISHERIES CREEKS

- 3.8.1. THE CONTRACTOR SHALL COMPLY WITH ALL REGULATORY AUTHORITIES, MINISTRY OF ENVIRONMENT, AND DEPARTMENT OF FISHERIES AND OCEANS CANADA IN THE PROTECTION OF FISH AND WILDLIFE DURING THE CONSTRUCTION OF CONTRACT WORKS AND SHALL BE RESPONSIBLE FOR ALL COSTS IN COMPLYING WITH THESE REQUIREMENTS.

3.9. CLEARING AND GRUBBING

- 3.9.1. THE CONTRACTOR SHALL, IN ACCORDANCE WITH THE ESC PLAN, BE RESPONSIBLE TO CLEAR-AND-GRUB AREAS NECESSARY TO CONSTRUCT THE WORKS AS SHOWN ON THE DRAWINGS.
- 3.9.2. THE CONTRACTOR SHALL ALSO BE RESPONSIBLE FOR THE REMOVAL AND DISPOSAL OFFSITE OF ALL DEBRIS AND STUMPS RESULTING FROM CLEARING AND GRUBBING OPERATIONS. THE COST OF SUCH WORKS SHALL BE INCLUDED IN THE PRICE BID FOR CLEARING AND GRUBBING.

3.10. EXISTING ROADWAY AND STRUCTURE REMOVAL

- 3.10.1. THE CONTRACTOR WILL BE RESPONSIBLE FOR THE REMOVAL OF THE EXISTING WALKWAYS, UTILITIES AND STRUCTURES WITHIN THE CONSTRUCTION ZONE ONSITE AS PROPOSED IN CONTRACT DRAWINGS. COSTS OF THIS SHALL BE INCLUDED IN THE CONTRACT PRICES.
- 3.10.2. DUMPING OF EXCAVATED MATERIAL WITHIN THE SITE WILL NOT BE ALLOWED.
- 3.10.3. ALL SURPLUS EXCAVATED MATERIAL SHALL BE DISPOSED OF OFF-SITE. ANY COSTS ASSOCIATED WITH THE EXCESS MATERIAL SHALL BE INCLUDED IN THE PRICES BID FOR THE RELATED WORKS.

3.11. ROCKS AND/OR BOULDERS

- 3.11.1. THE BLASTING AND REMOVAL OF ANY ROCKS OR BOULDERS FROM THE SITE SHALL BE THE RESPONSIBILITY AND COSTS OF THE CONTRACTOR. THE OWNER RESERVES THE RIGHT TO RETAIN THE BOULDERS FOR THEIR OWN USE.

3.12. BACKFILL

- 3.12.1. ALL BACKFILL SHALL BE IN ACCORDANCE WITH THE CITY OF COQUITLAM AND/OR UTILITY COMPANY DRAWINGS AND SPECIFICATIONS. IF APPROVED, SUBSTITUTION OF NATIVE BACKFILL FOR IMPORT BACKFILL MATERIAL MAY BE PERMITTED BY THE CONTRACTOR IF ALL NECESSARY GEOTECHNICAL DOCUMENTATION (LETTERS, REPORTS, ETC.) HAVE BEEN ACCEPTED BY THE CITY OF COQUITLAM AND THE ENGINEER OF RECORD.

3.13. ONSITE BACKFILL

- 3.13.1. ALL ONSITE BACKFILL SHALL BE IN ACCORDANCE WITH THE GEOTECHNICAL REPORT PREPARED BY THURBER ENGINEERING LTD. DATED MAY 5, 2023, AND IN COMPLIANCE WITH UTILITY COMPANY DRAWINGS AND SPECIFICATIONS.

3.14. SITE GRADING AND CUT/FILL EARTH WORKS

- 3.14.1. THE CONTRACTOR SHALL BE RESPONSIBLE FOR GRADING THE SITE IN ACCORDANCE WITH THE GRADING PLAN, ENSURING THAT THE SURFACE DRAINAGE OF THE SITE IS DIRECTED AS SET OUT ON THE PLAN. AS PART OF THE SILTATION AND EROSION CONTROL MEASURES, THE CONTRACTOR WILL TAKE WHATEVER ACTION IS NECESSARY TO MITIGATE THE IMPACT OF ADVERSE WEATHER CONDITIONS OVER AREAS OF EXPOSED SOILS TO PREVENT SOIL AND SEDIMENT FROM BEING WASHED OFF THE SITE AND INTO THE STORM DRAINAGE SYSTEM.
- 3.14.2. THE CONTRACTOR SHALL USE ALL SUITABLE MINERAL TRENCH EXCAVATION MATERIAL AND ROAD EXCAVATION MATERIAL WITHIN THE SITE AREA FOR SITE GRADING. IF THE CONTRACTOR IS REQUIRED TO STOCKPILE THE EXCAVATED MATERIAL, IT SHALL BE PROTECTED FROM THE ELEMENTS (WIND AND WATER) WITH POLY SHEETING AND SILT FENCING TO PREVENT EROSION OF THE MATERIAL. THE CONTRACTOR SHALL BE RESPONSIBLE FOR THE DISPOSAL OFFSITE OF ALL UNSUITABLE OR EXCESS MATERIAL.

3.15. TRENCH RESTORATION

- 3.15.1. THE CONTRACTOR IS RESPONSIBLE FOR RESTORATION OF ANY PAVEMENT, CURBS, SIDEWALKS, FENCING, AND LANDSCAPING DISTURBED IN CONSTRUCTION. THE COST TO FULLY REINSTATE ALL TRENCHES SHALL BE INCLUDED IN THE CONTRACT PRICE.
- 3.15.2. THE PRICE FOR ASPHALT OVERLAY SHALL INCLUDE THE CLEANING OF THE BASE ASPHALT, PLACEMENT OF A TACK COAT, AND ANY MANHOLE OR VALVE COVER ADJUSTMENTS AS REQUIRED.

3.16. TIE-INS AND CONNECTIONS TO EXISTING SERVICES

- 3.16.1. TIE-INS AND CONNECTIONS TO THE ONSITE EXISTING WATERMANS AND/OR SEWERS SHALL BE THE RESPONSIBILITY OF THE CONTRACTOR AND IS TO BE INCLUDED IN THE CONTRACT PRICE.

3.17. TESTING OF ONSITE SEWERS

- 3.17.1. TESTING OF THE ONSITE SEWER SYSTEM SHALL BE DONE BY THE CONTRACTOR AS PER THE PLUMBING PERMIT AND THE COST OF THIS SHALL BE INCLUDED IN THE SCHEDULE OF CONTRACT PRICES.
- 3.17.2. THE TESTS SHALL BE PERFORMED IN THE PRESENCE OF THE AUTHORIZED CITY OF COQUITLAM INSPECTOR, OR WITH SUCH APPROVAL, AN APPROVED TESTING COMPANY MAY UNDERTAKE THE TESTS IN ABSENCE OF THE CITY OF COQUITLAM INSPECTOR. COPIES OF THE TEST RECORDS, IN THE FORMAT REQUIRED BY THE CITY OR MUNICIPALITY, WILL BE FORWARDED TO CITY OF COQUITLAM INSPECTOR AND THE CONSULTANT FOR REVIEW.

3.18. VIDEO INSPECTION OF SEWERS

- 3.18.1. VIDEO INSPECTION OF THE STORM AND SANITARY SEWER SYSTEM, INCLUDING ALL CONNECTION LEADS, SHALL BE PERFORMED BY THE CONTRACTOR AND THE COST OF THIS SHALL BE INCLUDED IN THE SCHEDULE OF CONTRACT PRICES.
- 3.18.2. THE VIDEO INSPECTION SHALL BE PERFORMED IN THE PRESENCE OF THE AUTHORIZED CITY OF COQUITLAM INSPECTOR, OR WITH SUCH APPROVAL, AN APPROVED TESTING COMPANY MAY UNDERTAKE THE TESTS IN ABSENCE OF THE CITY OF COQUITLAM INSPECTOR. COPIES OF THE VIDEO RECORDS, IN THE FORMAT REQUIRED BY THE CITY OR MUNICIPALITY, WILL BE FORWARDED TO CITY OF COQUITLAM INSPECTOR AND THE CONSULTANT FOR REVIEW.

3.19. TESTING OF ONSITE WATERWORKS

- 3.19.1. DURING INSTALLATION AND PRIOR TO ARRANGING FOR TESTS BY THE CITY OF COQUITLAM FORCES, THE CONTRACTOR SHALL CARRY OUT AT HIS EXPENSE, HIS OWN TESTS TO ENSURE THAT THE SYSTEM WILL SATISFACTORILY PASS THE CITY TEST.
- 3.19.2. THE TESTING AND CHLORINATION OF ONSITE WATERMANS WILL BE DONE BY THE CONTRACTOR IN THE PRESENCE OF THE CITY OF COQUITLAM PLUMBING INSPECTOR.
- 3.19.3. SCHEDULE 40 OR 80 PIPE SHALL NOT BE USED FOR THE ONSITE WATERMANS.

3.20. MATERIALS TESTING

- 3.20.1. THE CONTRACTOR IS RESPONSIBLE FOR PROVIDING AND CO-ORDINATING ALL MATERIAL TESTING FOR ALL GRANULAR, ASPHALTIC AND CONCRETE MATERIALS USED IN CONSTRUCTION IN ACCORDANCE WITH THE REQUIREMENTS OF ALL LOCAL CITY OR MUNICIPAL JURISDICTIONS.
- 3.20.2. ALL TESTING MUST BE PERFORMED BY A CERTIFIED TESTING LABORATORY. THE TESTING WILL INCLUDE, BUT NOT LIMITED TO, SIEVE ANALYSIS OF MATERIALS TO BE TESTED; DENSITY TESTS FOR TRENCH BACKFILL MATERIALS, ROADWAY EMBANKMENTS AND ROAD CONSTRUCTION; DENSITY TESTS FOR GRANULAR MATERIALS USED IN LANE, ROAD AND SIDEWALK CONSTRUCTION; MARSHALL TESTS AND CORING OF ASPHALT PAVEMENTS; PLASTIC AND STRENGTH CONCRETE TESTS FOR SIDEWALKS, CURB AND GUTTER. PROOF ROLLING SHALL BE CARRIED OUT IN ACCORDANCE WITH MMCD SECTION 2233, ITEM 3.5.
- 3.20.3. THE CONTRACTOR IS ALSO RESPONSIBLE FOR ANY ADDITIONAL TESTS SPECIFICALLY IDENTIFIED ON THE CONTRACT DRAWINGS OR TENDER DOCUMENTS FOR COMPLIANCE WITH GEOTECHNICAL REPORTS, OR AS REQUIRED BY THE ENGINEER-OF-RECORD.
- 3.20.4. THE CONTRACTOR IS TO PROVIDE THE CONSULTANT WITH A TIMELY COPY OF ALL MATERIALS TESTING RESULTS IN THE FORMAT REQUIRED BY THE CITY OF COQUITLAM.

3.21. SITE LIGHTING, ELECTRICAL AND TELECOMMUNICATIONS

- 3.21.1. THE CONTRACTOR SHALL INSTALL PROPOSED SITE LIGHTING, ELECTRICAL AND TELECOMMUNICATIONS SYSTEMS IN ACCORDANCE WITH THE DRAWINGS, REQUIREMENTS, STANDARDS, AND SPECIFICATIONS OF THE ELECTRICAL ENGINEERING DRAWING SET.

3.22. FORTIS BC & GAS SERVICE INSTALLATION

- 3.22.1. THE OWNER IS MAKING ARRANGEMENTS WITH FORTIS BC TO EXTEND AND INSTALL SERVICES UP TO AND WITHIN THE SITE. THE CONTRACTOR SHALL COORDINATE HIS WORK WITH THE FORTIS BC CONTRACTOR DURING ALL GAS MAIN CONSTRUCTION. CONTRACTOR SHALL INSTALL THE GAS SERVICE IN ACCORDANCE WITH THE DRAWINGS, REQUIREMENTS, STANDARDS, AND SPECIFICATIONS OF THE FORTIS BC GAS AND MECHANICAL ENGINEERING DRAWING SETS. ASPHALT PAVING SHALL NOT BE ALLOWED TO PROCEED UNTIL ALL CROSSINGS ARE COMPLETED OR PRE-DUCTED. PAYMENT FOR PRE-DUCTING SHALL BE INCLUDED IN THE LUMP SUM ITEM FOR ROADWORKS.

3.23. RESTORATIONS

- 3.23.1. THE CONTRACTOR SHALL BE RESPONSIBLE FOR RESTORATION OF ANY AND ALL OFFSITE AND ONSITE PAVEMENTS, DRIVEWAYS, FENCING, DITCHES, LANDSCAPING, AND LAWNS DISTURBED DURING THE COURSE OF CONSTRUCTION. THE COST OF THE ABOVE WORKS SHALL BE INCLUDED IN THE CONTRACT PRICE.

3.24. PRE-CONSTRUCTION DAMAGE INSPECTION

- 3.24.1. THE CONTRACTOR SHALL ENSURE THAT A PRE-CONSTRUCTION DAMAGE INSPECTION BE PERFORMED WITH THE CITY OF COQUITLAM STAFF AND THE ENGINEER PRIOR TO ANY MOBILIZATION OR SITE WORK. RESTORATION OF ANY DAMAGE NOT IDENTIFIED DURING THE PRE-CONSTRUCTION DAMAGE INSPECTION WILL BE THE RESPONSIBILITY OF THE CONTRACTOR. SHOULD THE CONTRACTOR FAIL TO ARRANGE THIS PRE-CONSTRUCTION DAMAGE INSPECTION PRIOR TO MOBILIZATION, ALL DAMAGES IDENTIFIED BY THE CITY AND ENGINEER ARE TO BE REPAIRED AT THE CONTRACTOR'S COST.

3.25. AS-BUILT DRAWINGS

- 3.25.1. THE CONTRACTOR SHALL MAINTAIN IN GOOD CONDITION ON THE SITE, ONE COMPLETE SET OF BOTH OFFSITE AND ONSITE DRAWINGS FOR THE PURPOSE OF RECORDING ALL VARIATIONS FROM THE DRAWINGS. ALTERATIONS SHALL BE CLEARLY SHOWN IN RED. THIS SET WILL BE RETURNED TO THE CONSULTANT WITHIN ONE (1) WEEK AFTER SUBSTANTIAL COMPLETION OF THE CONTRACT TO ENABLE THE CONSULTANT TO PREPARE A PERMANENT SET OF "AS-BUILT" DRAWINGS. THE CONTRACTOR SHALL PROVIDE THE CONSULTANT DOCUMENTATION OF CHANGES WHICH SHALL PROVIDE ALL DETAILS APPLICABLE TO THE CHANGES.
- 3.25.2. CONTRACTOR TO RETAIN AND PROVIDE AS-BUILT SURVEY OF OFFSITE WORKS COMPLETED BY CERTIFIED BOLS TO FACILITATE PREPARATION OF CITY REQUIRED RECORD DRAWINGS.

3.26. PROVISIONAL ITEMS

- 3.26.1. THE OWNER RESERVES THE RIGHT TO INCLUDE OR EXCLUDE ALL PROVISIONAL ITEMS AT THE PRICES STATED.

3.27. PAYMENT CERTIFIER

- 3.27.1. FOR ALL WORKS TENDERED UNDER THIS CONTRACT, THE OWNER WILL BE THE PAYMENT CERTIFIER AS DEFINED IN THE BC LIEN ACT.

3.28. FREEDOM OF INFORMATION AND PROTECTION OF PRIVACY ACT

- 3.28.1. THE CONTRACTOR ACKNOWLEDGES THAT THE OWNER IS SUBJECT TO THE FREEDOM OF INFORMATION AND PROTECTION OF PRIVACY ACT AND AGREES TO ANY DISCLOSURE OF INFORMATION BY THE OWNER REQUIRED BY THE OWNER REQUIRED BY LAW.

3.29. PROGRESS DRAW REVIEW

- CIVIL PORTION OF MONTHLY PROGRESS DRAWS WILL BE REVIEWED AND EVALUATED BY APLIN MARTIN BASED ON THE FOLLOWING CRITERIA. A MAXIMUM 95% RELEASE WILL BE PERMITTED UNTIL SUBSTANTIAL COMPLETION HAS BEEN ISSUED BY THE CONSULTANT, EXCEPT FOR CLEARING & GRUBBING, EARTHWORKS AND VIDEO REPORTS (IF UNDER SEPARATE LINE ITEMS).

CLEARING & GRUBBING

- 100% WORKS COMPLETED

EARTHWORKS

- 0%-100% BASED ON PERCENT COMPLETION

STORM SEWER OR SANITARY SEWER

- 0%-70% BASED ON PERCENT COMPLETE
 - 70% ALL MAINLINES AND MANHOLES CONSTRUCTED
 - 85% SERVICES, INSPECTION CHAMBERS AND CATCH/LAWN BASINS CONSTRUCTED
 - 95% STORM SYSTEM COMPLETED AND CERTIFIED VIDEO REPORT ACCEPTED
- NOTE: 85% MAXIMUM FOR SEWERS UNTIL VIDEO REPORT AND AIR TEST (SANITARY SEWER) ARE ACCEPTED BY THE CONSULTANT.

WATERWORKS

- 0%-90% BASED ON PERCENT COMPLETE
 - 90% MAINLINES, VALVES, SERVICES AND HYDRANTS CONSTRUCTED
 - 95% LINES TESTED AND PASSED
- NOTE: 90% MAXIMUM FOR WATER MAIN UNTIL TESTING REPORTS ARE ACCEPTED BY THE CONSULTANT.

ROADWORKS


- 40% SUBBASE COMPLETED TO GRADE
- 65% CURB BASE AND CURBS CONSTRUCTED
- 75% GRANULAR BASE CONSTRUCTED TO GRADE AND TESTED
- 90% ASPHALT BASE COURSE PLACED

VIDEO INSPECTION

- 100% VIDEOS ARE RECEIVED AND APPROVED BY THE CONSULTANT



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No.	Date	By	Revisions
7	2025-05-05	RJB	ISSUED FOR RFP
6	2025-04-24	RJB	REISSUED FOR RFP REVIEW
5	2025-01-17	RJB	ISSUED FOR RFP REVIEW
4	2024-12-16	RJB	ISSUED FOR 100% REVIEW
3	2024-11-28	RJB	ISSUED FOR 85% REVIEW
2	2024-07-10	RJB	ISSUED FOR ALTERNATIVE COSTING
1	2024-05-08	RJB	ISSUED FOR 75% REVIEW

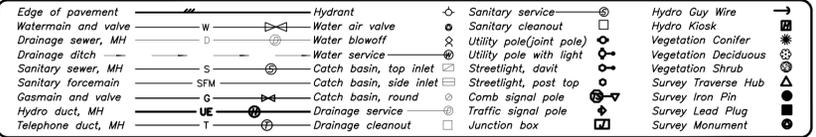Design by: ASB Date: MAY, 2024

Drawn by: ASB Date: MAY, 2024

Checked by: RJB Date: MAY, 2024

Approved by: RJB Date: MAY, 2024

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ACCEPTED FOR CONSTRUCTION
 Date: _____
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Scale horz. N/A Scale vert. N/A

Sheet of **26 of 26**

Eng. Project No. **PROJ 25-015**

Project: **BURKE MOUNTAIN ATHLETIC PARK**

Description: **CIVIL SPECIFICATIONS**

File: 18-264A