LEVEL 1

LEVEL 1

TOTAL PROPOSED FLOOR AREA:

LEVEL 2

LEVEL 2

103

103

103

104

OUTDOOR SPACE AREA			
Unit # Name Area			
101	BALCONY	6.3 m ²	
101	OUTDOOR PRIVATE SPACE	37.1 m ²	
101	OUTDOOR PRIVATE SPACE	8.6 m ²	
101: 3		52 m²	
102	BALCONY	6.2 m ²	
102	OUTDOOR PRIVATE SPACE	11.1 m ²	
102	OUTDOOR PRIVATE SPACE	26.4 m ²	
102: 3	43.7 m ²		
103	BALCONY	4 m²	
103	OUTDOOR PRIVATE SPACE	34.9 m ²	
103: 2	103: 2		
104	BALCONY	4 m²	
104	OUTDOOR PRIVATE SPACE	34.9 m ²	
104: 2		38.8 m²	

2 3D View 1 - Option B

DEVELOPMENT DATA SUMMARY

LOT COVERAGE:

Maximum Permitted Lot Coverage: 50%

Proposed Lot Coverage: Area Covered by Building: ___m² / Net Lot Area ___m² = ___m² (___%)

TOTAL FLOOR AREA:

<u>FSR:</u> Maximum Permitted: 0.75 x Lot Area = ____ m²

Proposed:

Floor Area	m² / Existing l	Lot Area ₋	$_{}$ m ² =	FSR
------------	-----------------	-----------------------	------------------------	-----

PRIVATE OUTDOOR AMENITY SPACE:

Minimum Required:

37 m² per unit

SETBACKS:

Minimum Required:

From Front Property Line = 5.5m From Rear Property Line = 6.0m Interior Side Property Line = 1.2m Exterior Side Property Line = 3.0m

Proposed:

From Front Property Line = 5.5m From Rear Property Line = 6.0m Interior Side Property Line = 1.2m Exterior Side Property Line = n/a

HEIGHT:

Maximum Permitted:

(ii) 11.0 metres for buildings and structures having a roof slope with a pitch of 3 in 12 or greater for an area of at least 80% of all roof surfaces.

Proposed Height

Proposed neight.		
Lowest of either Natural grade	or Finished grade at the building corn	er
Northwest corner = elevation _	metres	
Southwest corner = elevation	metres	

Northeast corner = elevation ___ Southeast corner = elevation metres Sum of all Elevations = Total = elevation ___

<u>Divide Total Elevation by 4 = Average Grade</u> = elevation ____ metres Top of Roof Peak Elevation =

Height = Difference between Average Grade and Roof Peak Elevation = elevation ____ metres

Garbage and Organic Waste:

Minimum Required:

Two carts per unit each. Cart measures 0.74 m front to back, 0.58 m side to side, and a height of 1.07 m.

Provided:

Garbage room for 2 carts measuring 1.31 m x 0.85 m internal per unit.

VEHICLE PARKING:

Minimum Required:

Fourplex Residential:

2 spaces per dwelling unit, of which a maximum of 100% may be tandem

parking spaces

Total: = 8 parking spaces

8 parking spaces Provided:

These plans are provided "as is" without any guarantee, representation or warranty of any kind, whether express, implied or statutory, and will require modification for use on a particular site. The City of Coquitlam (the "City") assumes no liability whatsoever with respect to your use of these plans or any errors or omissions herein. Any reliance on the accuracy, suitability, currency or completeness of the information contained in the plans is entirely at your own risk. These plans are the property of the City and may not be used, copied, reproduced or distributed in any way or for any purpose other than in

connection with a City development application.

Project: **FOURPLEX 1**

70.9 m²

73.8 m²

144.8 m²

70.9 m²

73.8 m²

144.8 m²

561.1 m²

STATISTICS

, Coquitlam, BC

Civic Address:

Legal Address:

Current Zoning:

Proposed Use:

Existing Lot Area:

Dedicated Lot Area: _

Net Lot Area: m²

DRAWING LIST - OPTION B

ELEVATIONS - OPTION B

ELEVATIONS - OPTION B

3D VIEWS - OPTION B

STATISTICS

SITE PLAN

LEVEL 1 PLAN

LEVEL 2 PLAN

ROOF PLAN

SECTIONS

SECTIONS

AREA PLANS

DETAILS

SHEET NAME

SPATIAL SEPARATION CALCULATIONS

Fourplex

Site Area:

SHEET

NUMBER

A002

A100

A500

A900

Grand total: 13

Issue Date: (YYYY-MM-DD) Drawn: **Revision Date:**

Checked: Project Number:

Drawing: **STATISTICS**

Scale:


1:1

ANKENMAN MARCHAND ARCHITECTS

1645 West 5th Avenue Vancouver, BC V6J 1N5

Tel: 604-872-2595 Email: office@amarchitects.com

DWG. No. A002

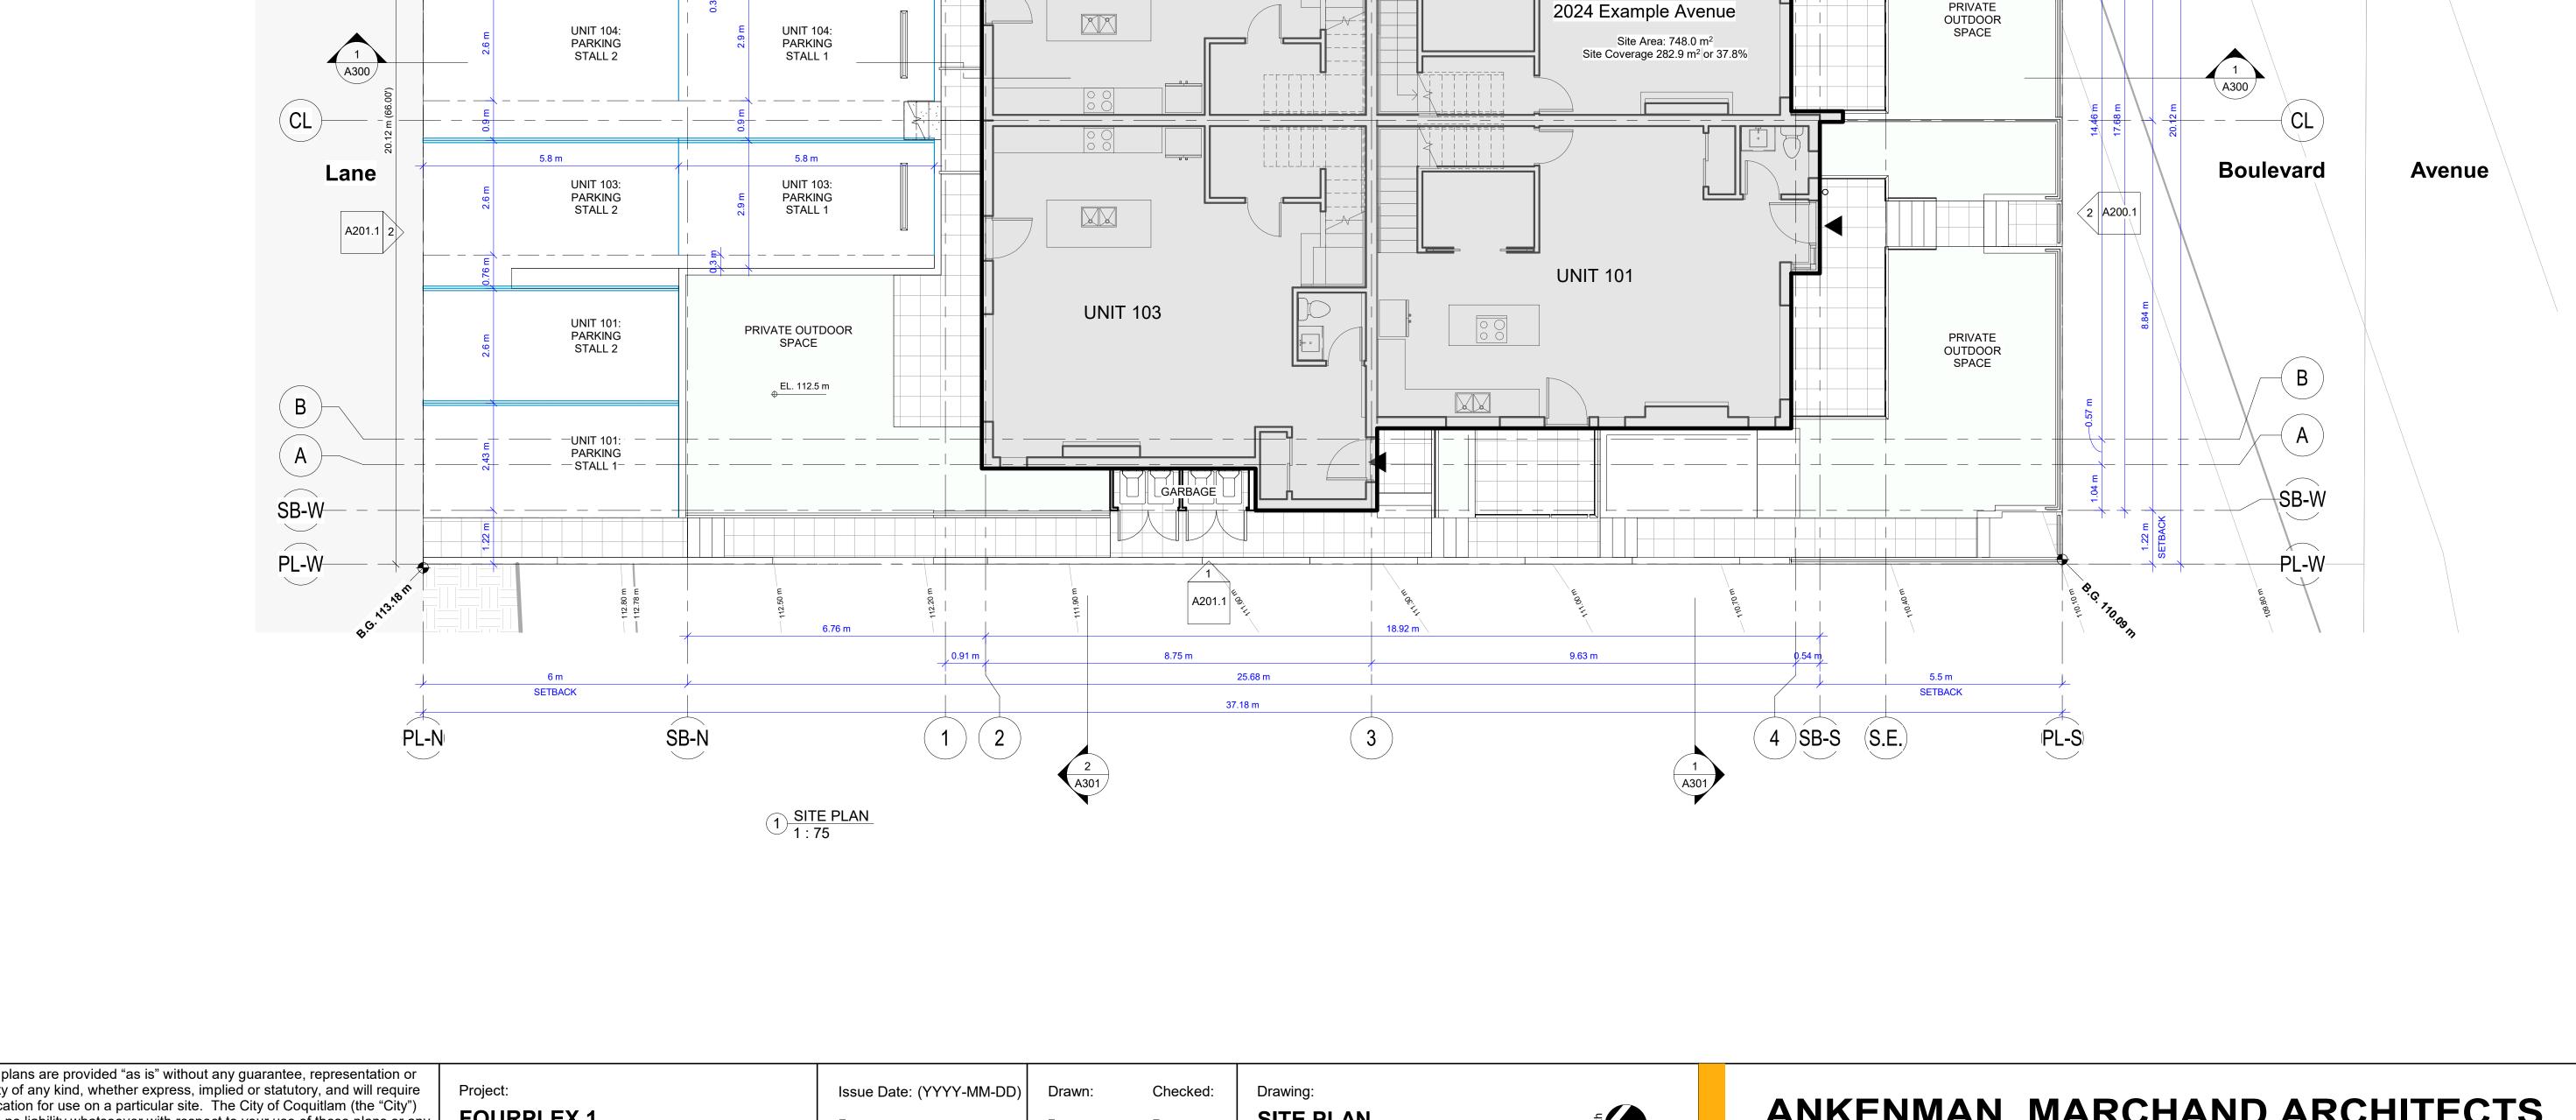

37.18 m (122.00')

A200.1

UNIT 104

These plans are provided "as is" without any guarantee, representation or warranty of any kind, whether express, implied or statutory, and will require modification for use on a particular site. The City of Coquitlam (the "City") assumes no liability whatsoever with respect to your use of these plans or any errors or omissions herein. Any reliance on the accuracy, suitability, currency or completeness of the information contained in the plans is entirely at your own risk. These plans are the property of the City and may not be used, copied, reproduced or distributed in any way or for any purpose other than in connection with a City development application.

SB-E

FOURPLEX 1

UNIT 102: PARKING STALL 2

UNIT 102: PARKING STALL 1

PRIVATE OUTDOOR SPACE

Note: If the retaining wall (or railing/fence) is below 0.3m (1ft) tall, this extra 0.3m spacing will not be required.

Revision Date:

Project Number:

SITE PLAN Scale: 1:75




DWG. No.

ELECTRICAL METERS (4)

UNIT 102

POSSIBLE LOCATION

PRIVATE

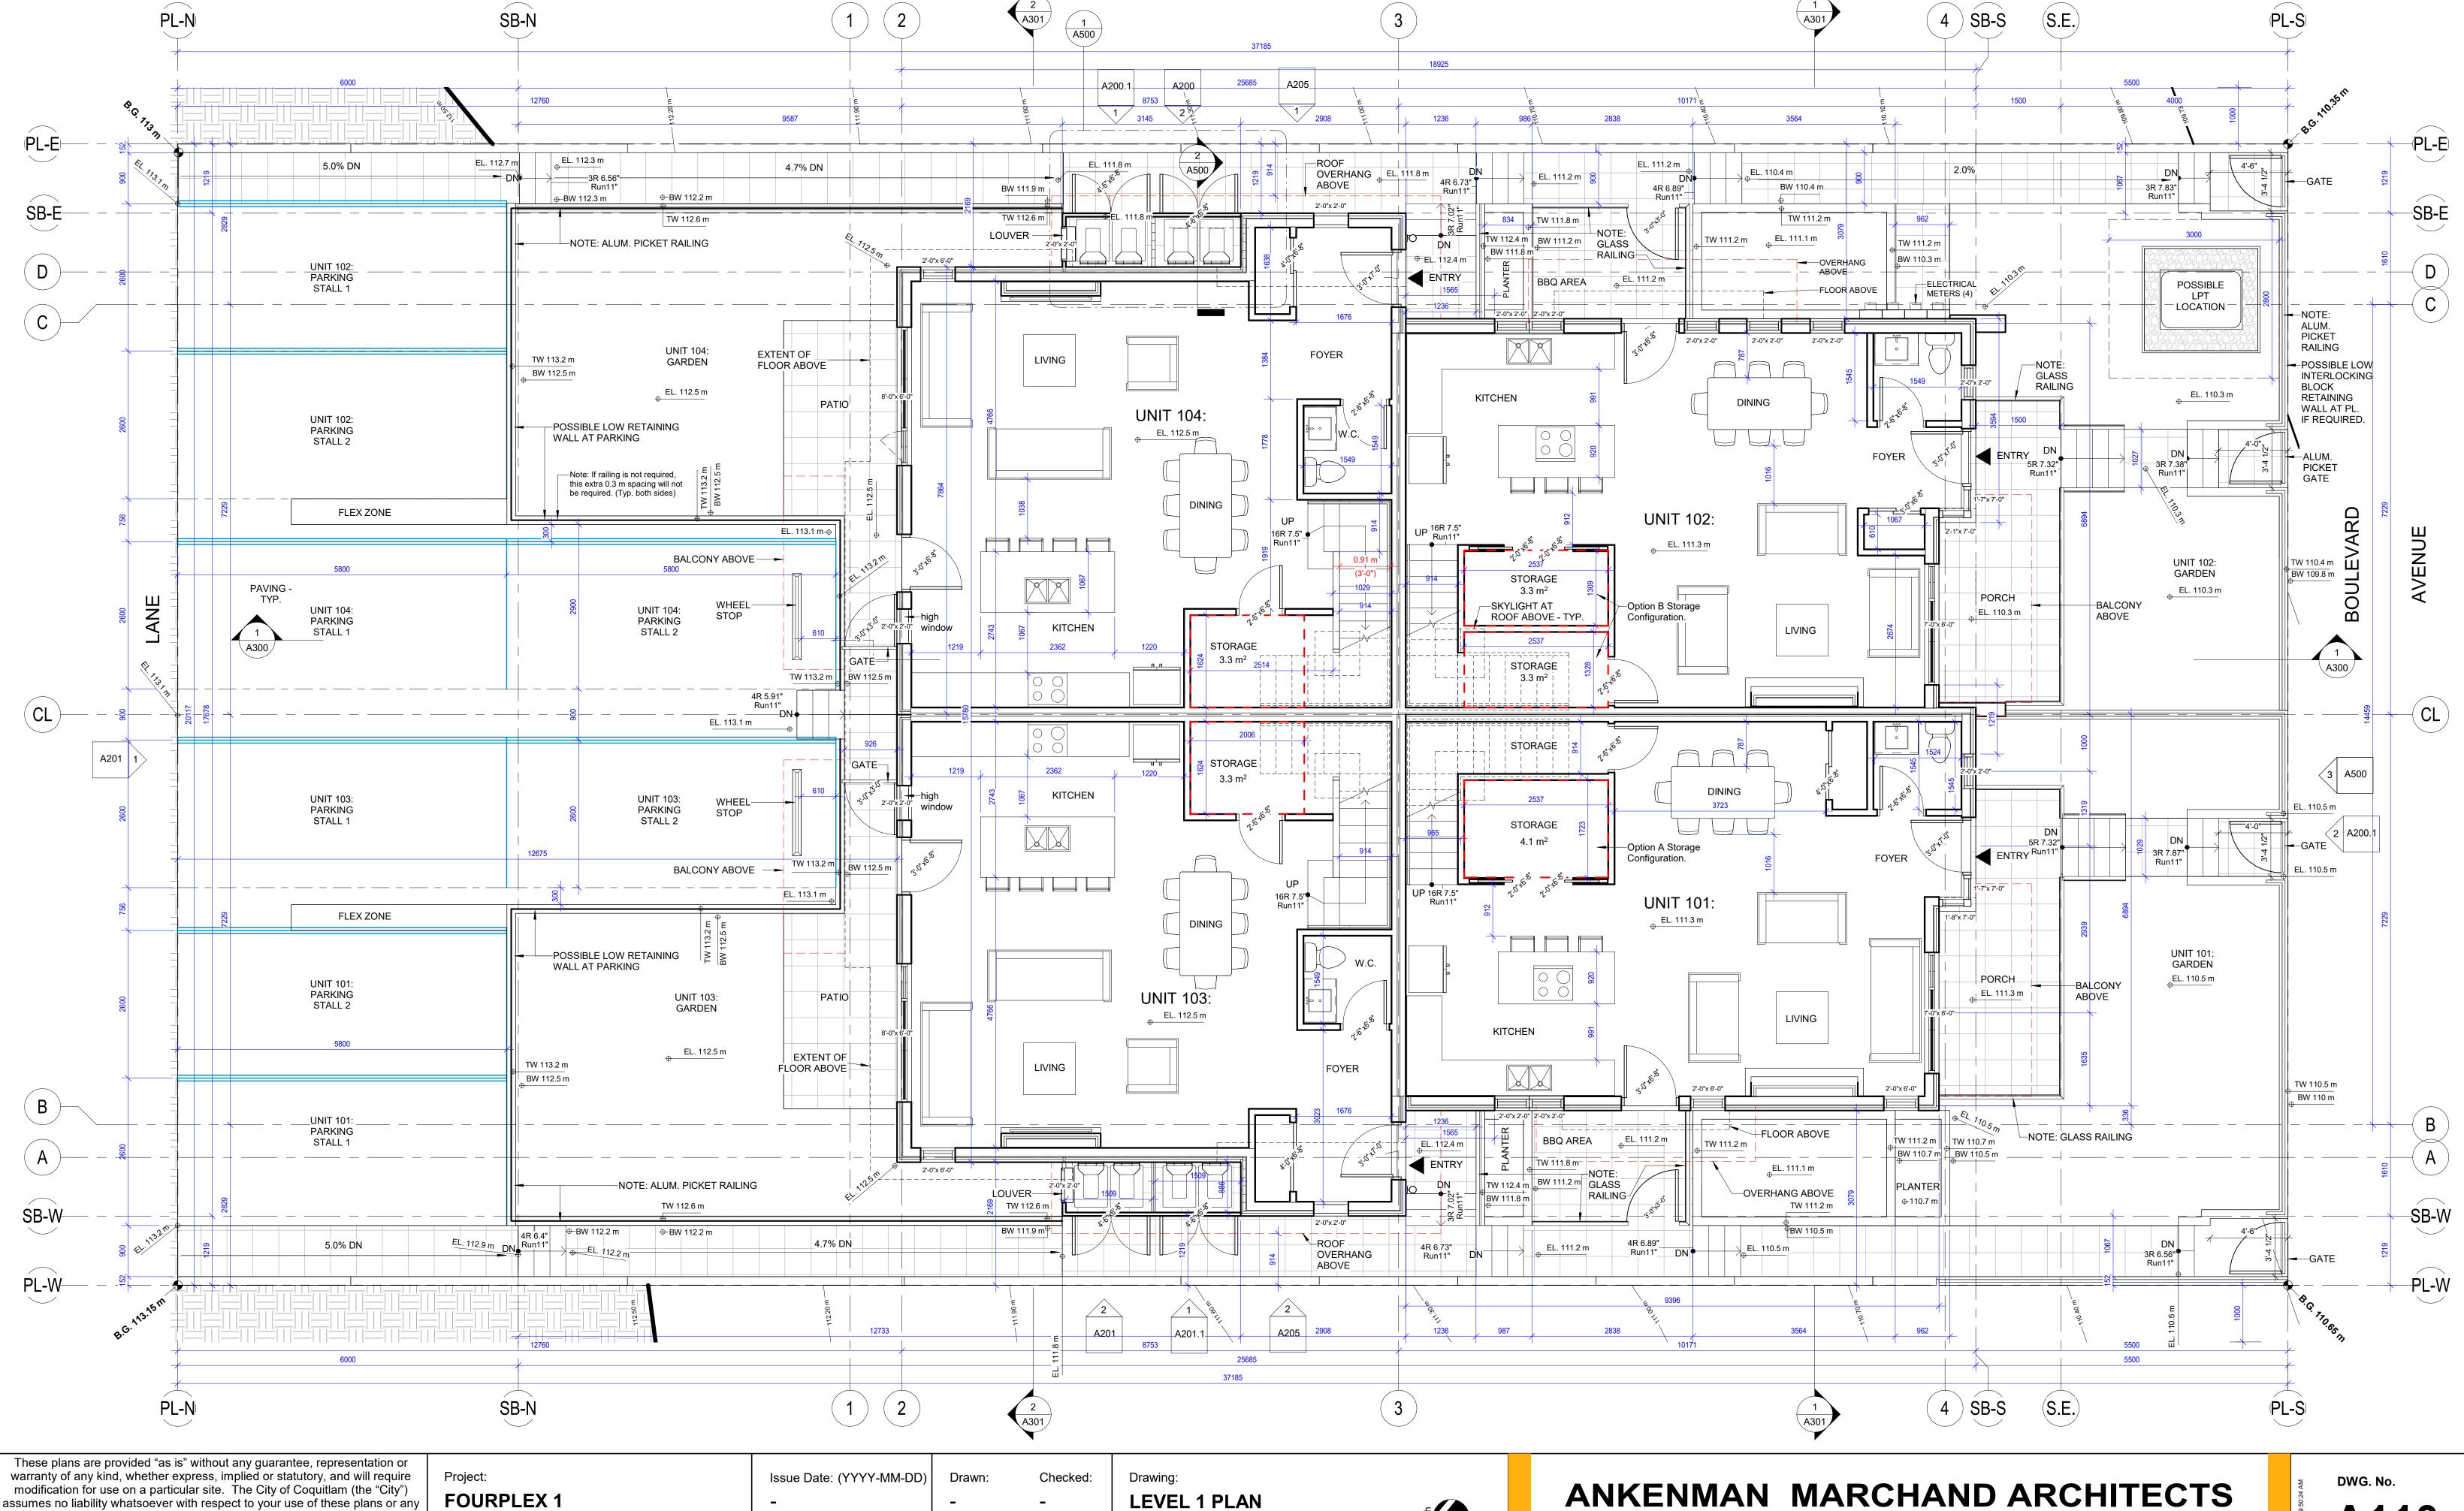

errors or omissions herein. Any reliance on the accuracy, suitability, currency or completeness of the information contained in the plans is entirely at your

own risk. These plans are the property of the City and may not be used,

connection with a City development application.

copied, reproduced or distributed in any way or for any purpose other than in

Project Number: **Revision Date:**

LEVEL 1 PLAN Scale: 1:50

north

ANKENMAN MARCHAND ARCHITECTS

1645 West 5th Avenue Vancouver, BC V6J 1N5

A110 Tel: 604-872-2595 Email: office@amarchitects.com

23-09-14 Thu 9:50:27 AM D:\001 REVIT LOCAL FILES\1926_03_MAIN_R20_CF_Fourplex1_slarose.n

These plans are provided "as is" without any guarantee, representation or warranty of any kind, whether express, implied or statutory, and will require modification for use on a particular site. The City of Coquitlam (the "City") assumes no liability whatsoever with respect to your use of these plans or any errors or omissions herein. Any reliance on the accuracy, suitability, currency or completeness of the information contained in the plans is entirely at your own risk. These plans are the property of the City and may not be used, copied, reproduced or distributed in any way or for any purpose other than in connection with a City development application.

FOURPLEX 1

Issue Date: (YYYY-MM-DD)

Revision Date:

Drawn: Checked:
- Project Number:

Drawing:

LEVEL 2 PLAN

Scale:

1:50

hoof

ANKENMAN MARCHAND ARCHITECTS

1645 West 5th Avenue Vancouver, BC V6J 1N5

Tel: 604-872-2595 Email: office@amarchitects.com A120

Plot Date: 2023-09-14 Thu 9:50:27 AM D:\001 REVIT LOCAL FILES\1926_03_MAIN_R20

These plans are provided "as is" without any guarantee, representation or warranty of any kind, whether express, implied or statutory, and will require modification for use on a particular site. The City of Coquitlam (the "City") assumes no liability whatsoever with respect to your use of these plans or any errors or omissions herein. Any reliance on the accuracy, suitability, currency or completeness of the information contained in the plans is entirely at your own risk. These plans are the property of the City and may not be used, copied, reproduced or distributed in any way or for any purpose other than in connection with a City development application.

Project:
FOURPLEX 1

Issue Date: (YYYY-MM-Decomposition Date:

Drawn: Checked:
- Project Number:

Drawing:

ROOF PLAN

Scale:
1:50



ANKENMAN MARCHAND ARCHITECTS

1645 West 5th Avenue Vancouver, BC V6J 1N5

Tel: 604-872-2595 Email: office@amarchitects.com A130

Issue Date: (YYYY-MM-DD)

Revision Date:

Checked: Project Number:

Drawn:

Drawing: **ELEVATIONS - OPTION B** Scale: 1:50

ANKENMAN MARCHAND ARCHITECTS

1645 West 5th Avenue

Vancouver, BC V6J 1N5

Tel: 604-872-2595 Email: office@amarchitects.com

MATERIAL LEGEND

INTERLOCKING BLOCK RETAINING WALL, COLOUR: NATURAL STONE GRAY

GRID PATTERN, FINISH: SMOOTH, COLOUR: LIGHT MIST

GRID PATTERN, FINISH: SMOOTH, COLOUR: IRON GRAY

GRID PATTERN, FINISH: SMOOTH, COLOUR: ARCTIC WHITE

BRICK, STACKED BOND, COLOUR: DARK BROWN OR SIMILAR BRICK, STACKED BOND, COLOUR: LIGHT BROWN OR SIMILAR

VINYL GLAZED PATIO/BALCONY DOOR, FRAME COLOUR: IRON GRAY

GARBAGE ROOM DOOR, METAL FRAME LOCKING, COLOUR: IRON GRAY

HARDIE FASCIA, 0.75"x11.25", FINISH: SMOOTH, COLOUR: IRON GRAY

VINYL WINDOWS, FRAME COLOUR: IRON GRAY

MULLION AND DOOR COLOUR: FOREST GREEN

RAILING - ALUMINUM PICKET, COLOUR: IRON GRAY ROOF - ASPHALT SHINGLES, COLOUR: MEDIUM GRAY

MULLION AND DOOR COLOUR: IRON GREY

Number

Material

EXPOSED ARCHITECTURAL CAST-IN-PLACE CONCRETE WALL / PEDESTAL / STAIR / RAMP

FIBER CEMENT REVEAL PANEL SYSTEM, REVEAL RECESS TRIM COLOUR TO MATCH, 4'x 8'

FIBER CEMENT REVEAL PANEL SYSTEM, REVEAL RECESS TRIM COLOUR TO MATCH, 4'x 8'

FIBER CEMENT LAP SIDING, FINISH: TRUE GRAIN SERIES, COLOUR: CEDARTONE

FIBER CEMENT LAP SIDING, FINISH: TRUE GRAIN SERIES, COLOUR: EMPIRE GREY

UNIT ENTRANCE DOOR, PREFINISHED ALUMINUM, HIGH EFFICIENCY, DOUBLE GLAZED,

UNIT ENTRANCE DOOR, PREFINISHED ALUMINUM, HIGH EFFICIENCY, DOUBLE GLAZED,

GARBAGE ROOM DOOR. METAL FRAME LOCKING, COLOUR: DARK BROWN OR SIMILAR GARBAGE ROOM DOOR, METAL FRAME LOCKING, COLOUR; LIGHT BROWN OR SIMILAR

RAILING, POWDER COATED ALUMINUM, GLASS PANEL, COLOUR: COLOUR: IRON GRAY OR

FIBER CEMENT LAP SIDING, FINISH: TRUE GRAIN SERIES, COLOUR: BEECH

DWG. No.





1 WEST ELEVATION Opt B 1:50

Issue Date: (YYYY-MM-DD) **Revision Date:**

Checked: Project Number:

Drawn:


Drawing: **ELEVATIONS - OPTION B** Scale: 1:50

ANKENMAN MARCHAND ARCHITECTS

1645 West 5th Avenue Vancouver, BC V6J 1N5

DWG. No. A201.1



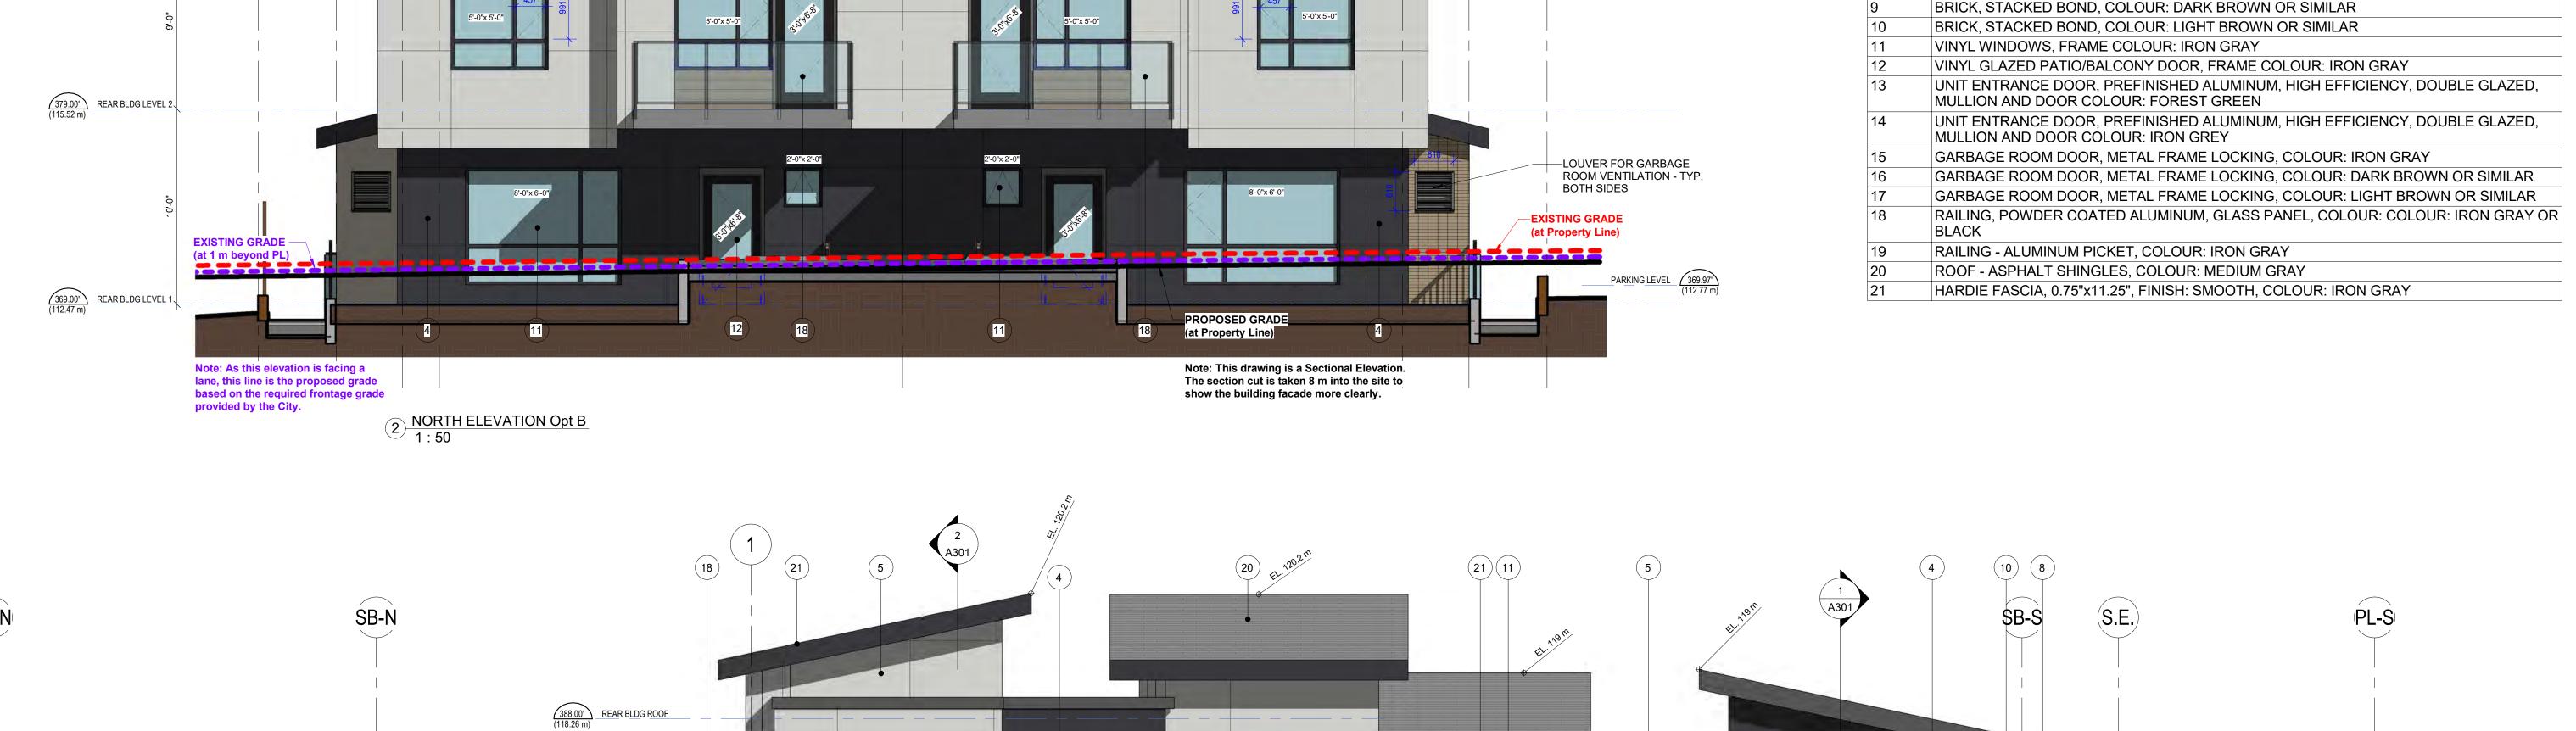



Tel: 604-872-2595

Email: office@amarchitects.com

MATERIAL LEGEND

INTERLOCKING BLOCK RETAINING WALL, COLOUR: NATURAL STONE GRAY

GRID PATTERN, FINISH: SMOOTH, COLOUR: LIGHT MIST

GRID PATTERN, FINISH: SMOOTH, COLOUR: IRON GRAY

GRID PATTERN, FINISH: SMOOTH, COLOUR: ARCTIC WHITE

Number

Material

EXPOSED ARCHITECTURAL CAST-IN-PLACE CONCRETE WALL / PEDESTAL / STAIR / RAMP

FIBER CEMENT REVEAL PANEL SYSTEM, REVEAL RECESS TRIM COLOUR TO MATCH, 4'x 8'

FIBER CEMENT REVEAL PANEL SYSTEM, REVEAL RECESS TRIM COLOUR TO MATCH, 4'x 8'

FIBER CEMENT REVEAL PANEL SYSTEM, REVEAL RECESS TRIM COLOUR TO MATCH, 4'x 8'

FIBER CEMENT LAP SIDING, FINISH: TRUE GRAIN SERIES, COLOUR: CEDARTONE

FIBER CEMENT LAP SIDING, FINISH: TRUE GRAIN SERIES, COLOUR: EMPIRE GREY

FIBER CEMENT LAP SIDING, FINISH: TRUE GRAIN SERIES, COLOUR: BEECH

These plans are provided "as is" without any guarantee, representation or warranty of any kind, whether express, implied or statutory, and will require modification for use on a particular site. The City of Coquitlam (the "City") assumes no liability whatsoever with respect to your use of these plans or any errors or omissions herein. Any reliance on the accuracy, suitability, currency or completeness of the information contained in the plans is entirely at your own risk. These plans are the property of the City and may not be used, copied, reproduced or distributed in any way or for any purpose other than in connection with a City development application.

Project: **FOURPLEX 1** Issue Date: (YYYY-MM-DD) **Revision Date:**

Checked: Drawn: Project Number:

Drawing: **SPATIAL SEPARATION CALCULATIONS** Scale: 1:75

ANKENMAN MARCHAND ARCHITECTS

1645 West 5th Avenue Vancouver, BC V6J 1N5

Tel: 604-872-2595 Email: office@amarchitects.com

DWG. No. **A205**

1 WEST N-S SITE SECTION 1:50

These plans are provided "as is" without any guarantee, representation or warranty of any kind, whether express, implied or statutory, and will require modification for use on a particular site. The City of Coquitlam (the "City") assumes no liability whatsoever with respect to your use of these plans or any errors or omissions herein. Any reliance on the accuracy, suitability, currency or completeness of the information contained in the plans is entirely at your own risk. These plans are the property of the City and may not be used, copied, reproduced or distributed in any way or for any purpose other than in connection with a City development application.

Project: **FOURPLEX 1** Issue Date: (YYYY-MM-DD) **Revision Date:**

Drawn: Checked: Project Number:

Drawing: **SECTIONS** Scale: 1:50

ANKENMAN MARCHAND ARCHITECTS


1645 West 5th Avenue Vancouver, BC V6J 1N5


Tel: 604-872-2595 Email: office@amarchitects.com


DWG. No. **A300**

AVENUE

FRONT BLDG LEVEL 1 (365.00') (111.25 m)

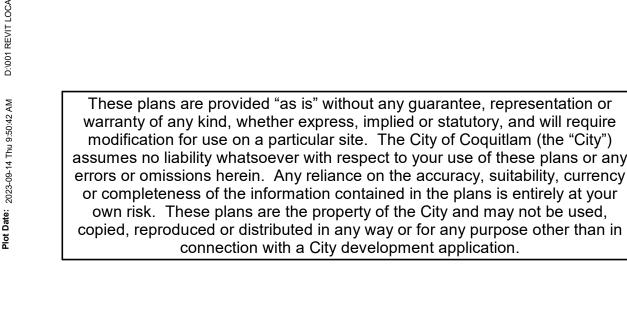

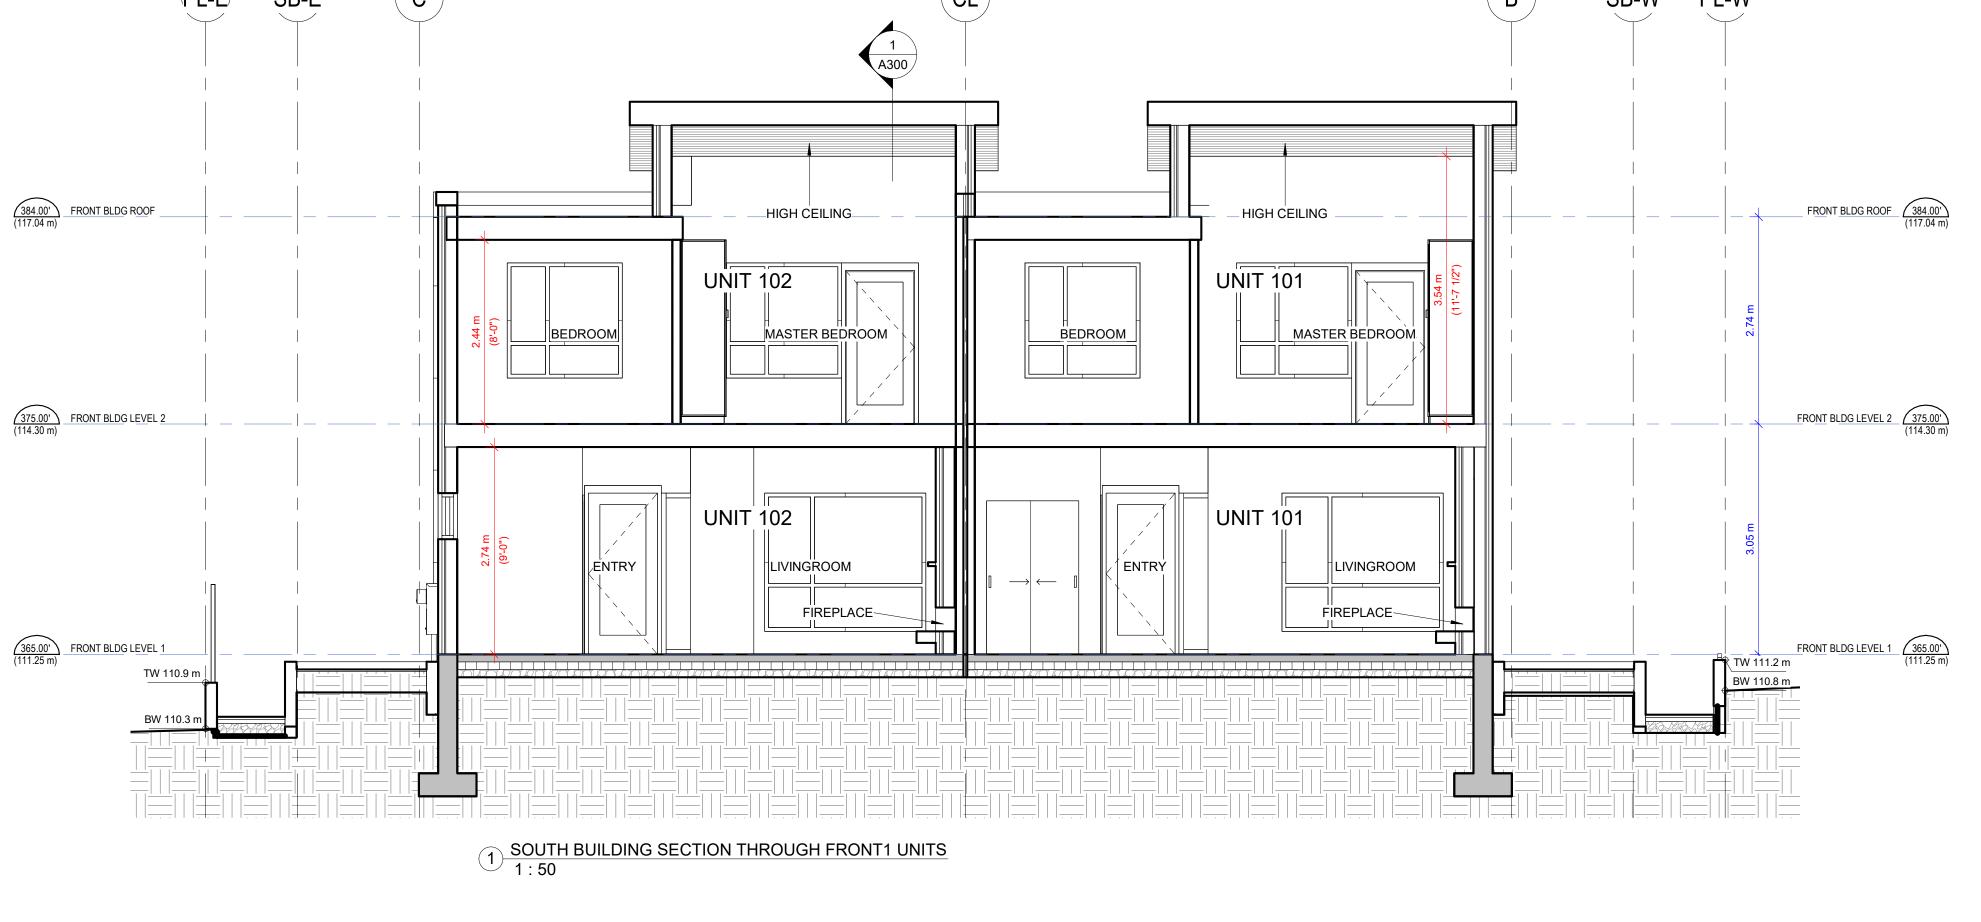

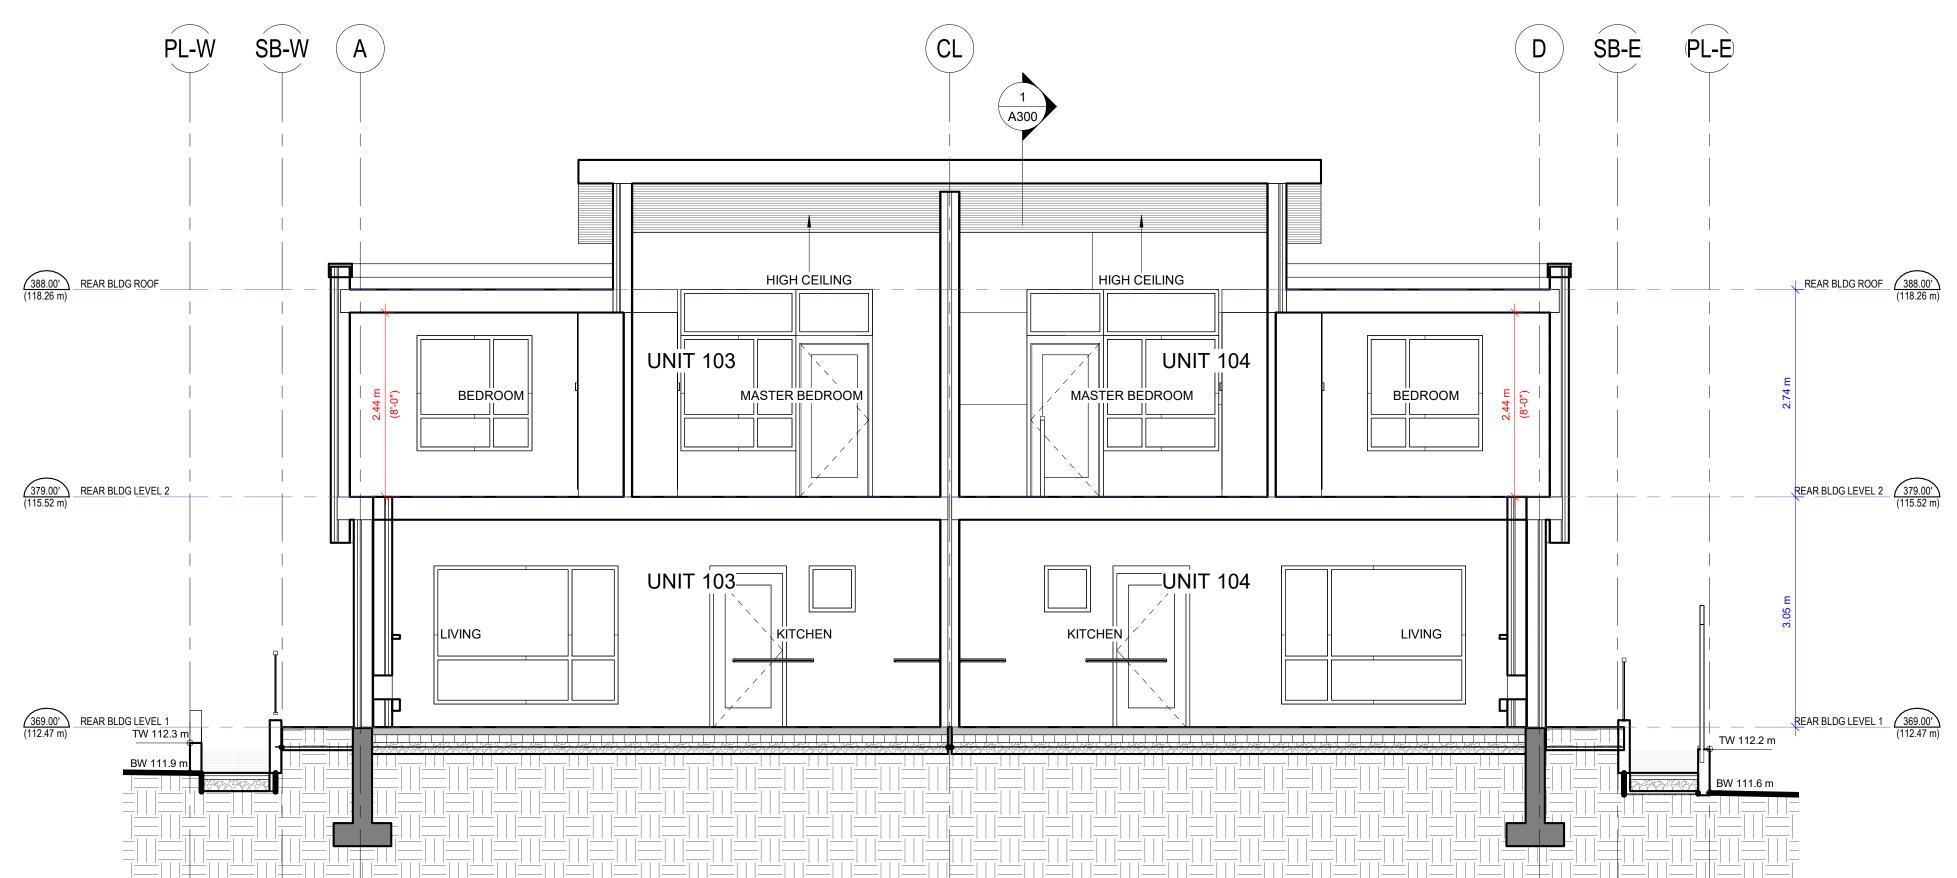

2 SOUTH BUILDING SECTION THROUGH REAR UNITS 1:50

Project: Issue Date: (YYYY-MM-DD) Drawn: Checked: Drawing: **FOURPLEX 1 SECTIONS** Project Number: Scale: Revision Date: 1:50

ANKENMAN MARCHAND ARCHITECTS

1645 West 5th Avenue Vancouver, BC V6J 1N5

A301 Tel: 604-872-2595 Email: office@amarchitects.com

DWG. No.

1. FENCE TO HAVE 2 COATS OF POWDER

3'-0"

2022

-ADDRESS NUMBER

1" x 5/8" ALUM. PICKETS

—1" THICK ALUMINUM TOP

-2" ALUM. TOP AND **BOTTOM RAILS**

-1" x 5/8" ALUM. PICKETS

-MASONRY RETAINING WALL

COAT IN BLACK OR IRON GRAY.

4" POST, 8' O.C. MAX.—

FENCE-

3 FENCE AND GATE DETAIL 1: 10

—2" ALUM. FRAME,

WELDED CONNECTIONS


Issue Date: (YYYY-MM-DD) Drawn: **Revision Date:** Project Number:


Checked:

Drawing: **DETAILS** As indicated

MATERIAL LEGEND Material Number EXPOSED ARCHITECTURAL CAST-IN-PLACE CONCRETE WALL / PEDESTAL / STAIR / RAMP INTERLOCKING BLOCK RETAINING WALL, COLOUR: NATURAL STONE GRAY FIBER CEMENT REVEAL PANEL SYSTEM, REVEAL RECESS TRIM COLOUR TO MATCH, 4'x 8' GRID PATTERN, FINISH: SMOOTH, COLOUR: LIGHT MIST FIBER CEMENT REVEAL PANEL SYSTEM, REVEAL RECESS TRIM COLOUR TO MATCH, 4'x 8' GRID PATTERN, FINISH: SMOOTH, COLOUR: IRON GRAY FIBER CEMENT REVEAL PANEL SYSTEM, REVEAL RECESS TRIM COLOUR TO MATCH, 4'x 8' GRID PATTERN, FINISH: SMOOTH, COLOUR: ARCTIC WHITE FIBER CEMENT LAP SIDING, FINISH: TRUE GRAIN SERIES, COLOUR: CEDARTONE FIBER CEMENT LAP SIDING, FINISH: TRUE GRAIN SERIES, COLOUR: BEECH FIBER CEMENT LAP SIDING, FINISH: TRUE GRAIN SERIES, COLOUR: EMPIRE GREY BRICK, STACKED BOND, COLOUR: DARK BROWN OR SIMILAR BRICK, STACKED BOND, COLOUR: LIGHT BROWN OR SIMILAR VINYL WINDOWS, FRAME COLOUR: IRON GRAY VINYL GLAZED PATIO/BALCONY DOOR, FRAME COLOUR: IRON GRAY UNIT ENTRANCE DOOR, PREFINISHED ALUMINUM, HIGH EFFICIENCY, DOUBLE GLAZED, MULLION AND DOOR COLOUR: FOREST GREEN UNIT ENTRANCE DOOR, PREFINISHED ALUMINUM, HIGH EFFICIENCY, DOUBLE GLAZED, MULLION AND DOOR COLOUR: IRON GREY GARBAGE ROOM DOOR, METAL FRAME LOCKING, COLOUR: IRON GRAY GARBAGE ROOM DOOR, METAL FRAME LOCKING, COLOUR: DARK BROWN OR SIMILAR GARBAGE ROOM DOOR, METAL FRAME LOCKING, COLOUR: LIGHT BROWN OR SIMILAR RAILING, POWDER COATED ALUMINUM, GLASS PANEL, COLOUR: COLOUR: IRON GRAY OR RAILING - ALUMINUM PICKET, COLOUR: IRON GRAY ROOF - ASPHALT SHINGLES, COLOUR: MEDIUM GRAY

HARDIE FASCIA, 0.75"x11.25", FINISH: SMOOTH, COLOUR: IRON GRAY

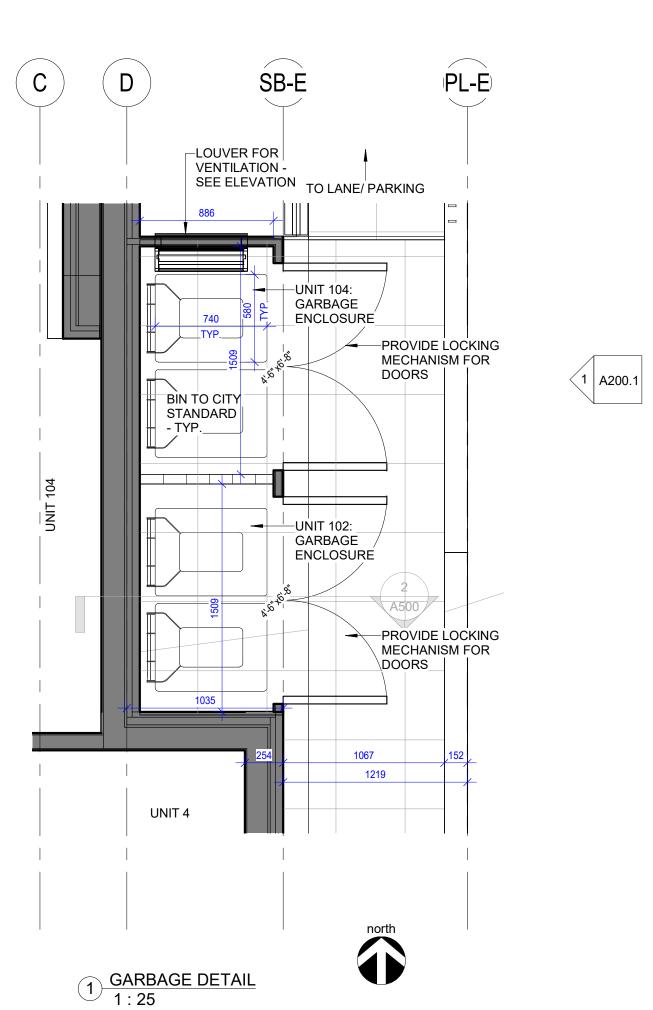

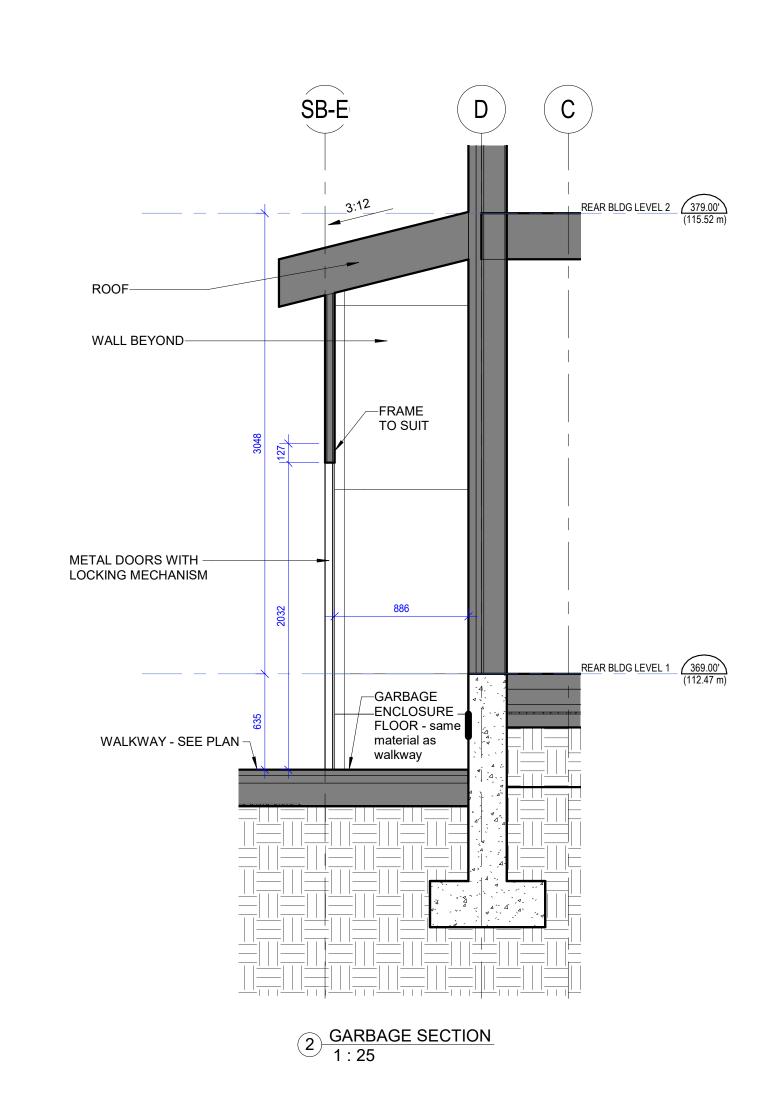

ANKENMAN MARCHAND ARCHITECTS

1645 West 5th Avenue Vancouver, BC V6J 1N5

Tel: 604-872-2595 Email: office@amarchitects.com

DWG. No. **A500**







2 3D View 5 opt B

These plans are provided "as is" without any guarantee, representation or warranty of any kind, whether express, implied or statutory, and will require modification for use on a particular site. The City of Coquitlam (the "City") assumes no liability whatsoever with respect to your use of these plans or any errors or omissions herein. Any reliance on the accuracy, suitability, currency or completeness of the information contained in the plans is entirely at your own risk. These plans are the property of the City and may not be used, copied, reproduced or distributed in any way or for any purpose other than in connection with a City development application.

Project: FOURPLEX 1

Issue Date: (YYYY-MM-DD) Revision Date:

Checked: Drawn:

Project Number:

Drawing: 3D VIEWS - OPTION B

Scale:

ANKENMAN MARCHAND ARCHITECTS

1645 West 5th Avenue Vancouver, BC V6J 1N5

A600.1 Tel: 604-872-2595 Email: office@amarchitects.com

DWG. No.





FLOOR AREA (m2)				
Unit #	Level	Area		
101	. LEVEL 1	67.3 m ²		
101	. LEVEL 2	68.1 m ²		
101		135.4 m²		
102	. LEVEL 1	67.3 m ²		
102	. LEVEL 2	68.8 m ²		
102 136.1 m ²				
103	. LEVEL 1	70.9 m ²		
103	. LEVEL 2	73.8 m ²		
103		144.8 m²		
104	. LEVEL 1	70.9 m ²		
104	. LEVEL 2	73.8 m²		
104		144.8 m²		
TOTAL	PROPOSED FLOOR AREA:	561.1 m²		

FLOOR AREA (SF)			
Unit #	Level	Area	
101	. LEVEL 1	725 SF	
101	LEVEL 2	733 SF	
101: 2		1457 SF	
102	. LEVEL 1	724 SF	
102	. LEVEL 2	741 SF	
102: 2		1465 SF	
103	. LEVEL 1	764 SF	
103	. LEVEL 2	795 SF	
103: 2		1559 SF	
104	. LEVEL 1	764 SF	
104	. LEVEL 2	795 SF	
104: 2		1559 SF	
TOTAL	PROPOSED FLOOR AREA:	6040 SF	

Unit#	Name	Area
101	BALCONY	6.3 m ²
101	OUTDOOR PRIVATE SPACE	37.1 m ²
101	OUTDOOR PRIVATE SPACE	8.6 m ²
101: 3		52 m²
	_	
102	BALCONY	6.2 m ²
102	OUTDOOR PRIVATE SPACE	11.1 m ²
102	OUTDOOR PRIVATE SPACE	26.4 m²
102: 3		43.7 m ²
	-	
103	BALCONY	4 m ²
103	OUTDOOR PRIVATE SPACE	34.9 m²
103: 2		38.8 m²
104	BALCONY	4 m ²
104	OUTDOOR PRIVATE SPACE	34.9 m ²
104: 2		38.8 m ²

These plans are provided "as is" without any guarantee, representation or warranty of any kind, whether express, implied or statutory, and will require modification for use on a particular site. The City of Coquitlam (the "City") assumes no liability whatsoever with respect to your use of these plans or any errors or omissions herein. Any reliance on the accuracy, suitability, currency or completeness of the information contained in the plans is entirely at your own risk. These plans are the property of the City and may not be used, copied, reproduced or distributed in any way or for any purpose other than in connection with a City development application.

Project:

PL-WSB-W


FOURPLEX 1 Revision Date:

Issue Date: (YYYY-MM-DD) Drawn:

Checked: Project Number:

Drawing: **AREA PLANS** Scale: 1:100

PL-W3B-W

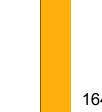


ANKENMAN MARCHAND ARCHITECTS

1645 West 5th Avenue Vancouver, BC V6J 1N5

Tel: 604-872-2595 Email: office@amarchitects.com

DWG. No. A900

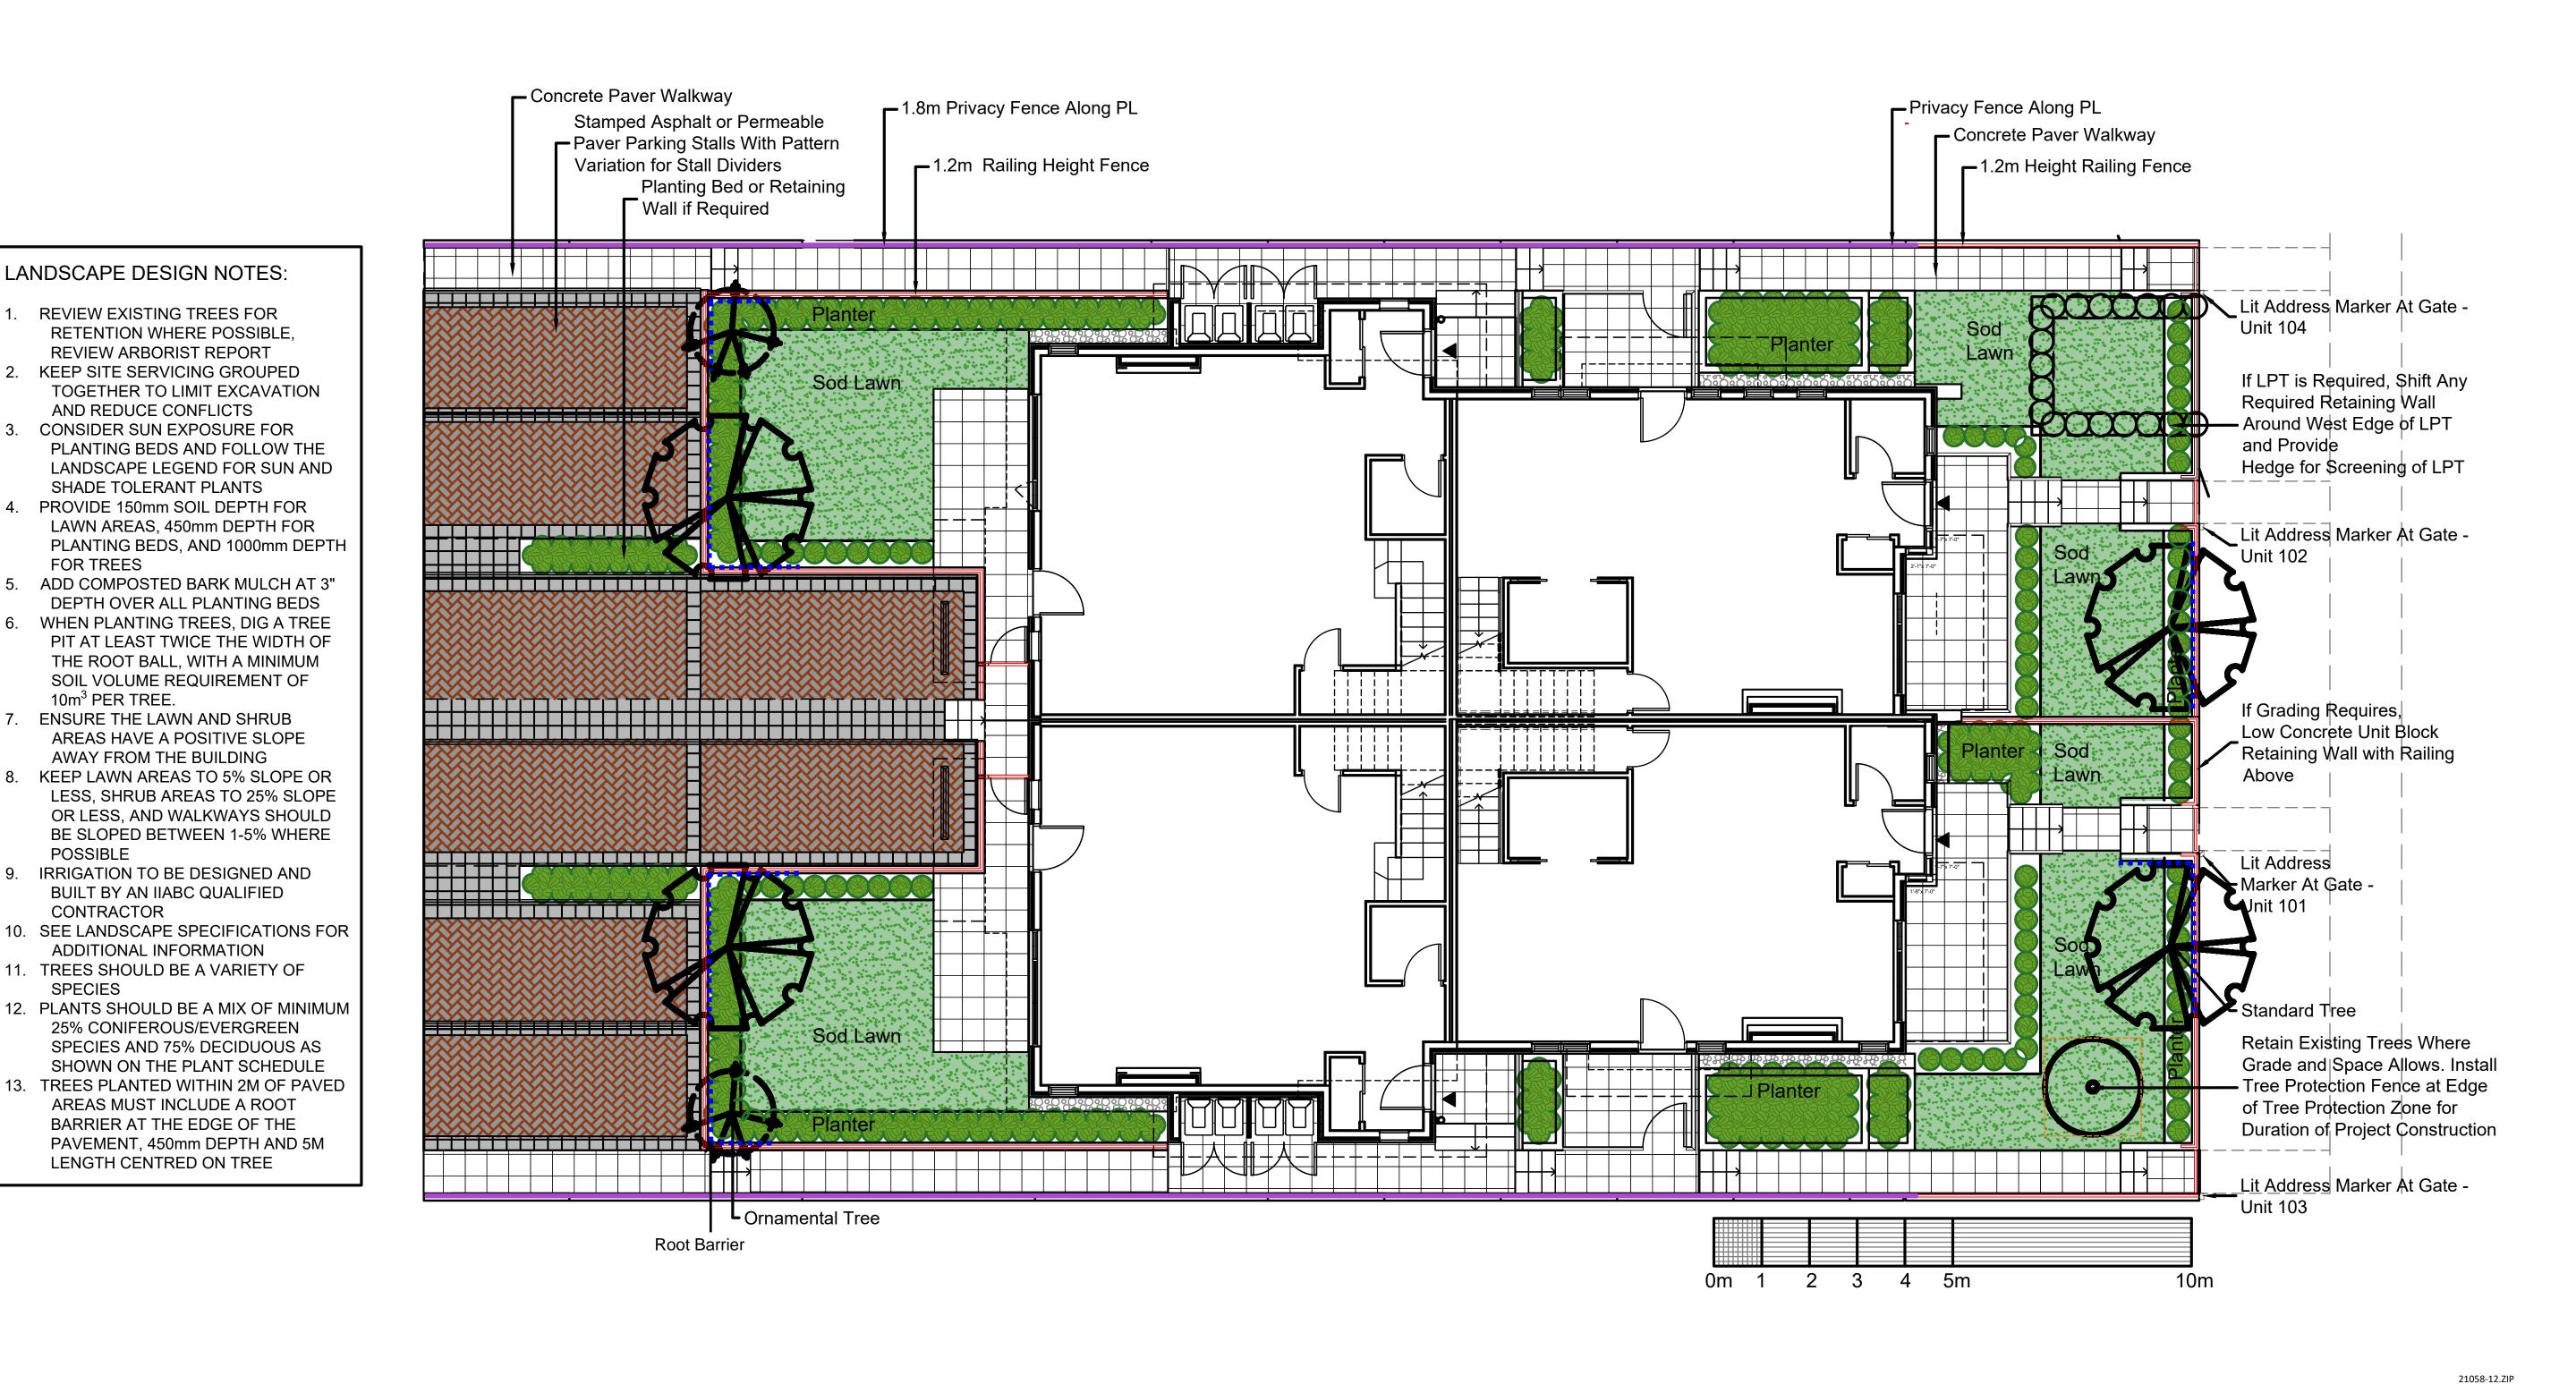



LANDSCAPE DESIGN NOTES:

REVIEW EXISTING TREES FOR

REVIEW ARBORIST REPORT

AND REDUCE CONFLICTS

SHADE TOLERANT PLANTS

AWAY FROM THE BUILDING

BUILT BY AN IIABC QUALIFIED

ADDITIONAL INFORMATION

LENGTH CENTRED ON TREE

FOR TREES

10m³ PER TREE.

POSSIBLE

SPECIES

CONTRACTOR

CITY OF COQUITLAM


These plans are provided "as is" without any guarantee, representation or warranty of any kind, whether express, implied or statutory, and will require modification for use on a particular site. The City of Coquitlam (the "City") assumes no liability whatsoever with respect to your use of these plans or any errors or omissions herein. Any reliance on the accuracy, suitability, currency or completeness of the information contained in the plans is entirely at your own risk. These plans are the property of the City and may not be used, copied, reproduced or distributed in any way or for any purpose other than in connection with a City development application.


10 22.JAN.13 REVISE PER CITY COMMENTS 3 21.NOV.29 7 21.NOV.14 REVISE PER CITY COMMENTS 6 21.SEP.29 REVISE PER CITY COMMENTS 5 21.AUG.03 1 21.APR.23 REVISE PER CITY COMMENTS NO. DATE REVISION DESCRIPTION

FOURPLEX 1

PROJECT:

DRAWING TITLE: **LANDSCAPE** CHK'D: **PLAN** DRAWING NUMBER: PMG PROJECT NUMBER: 21-058

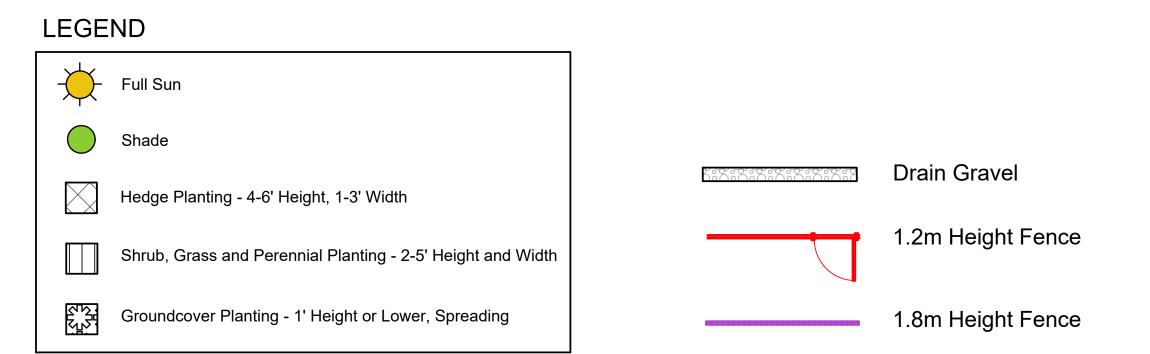

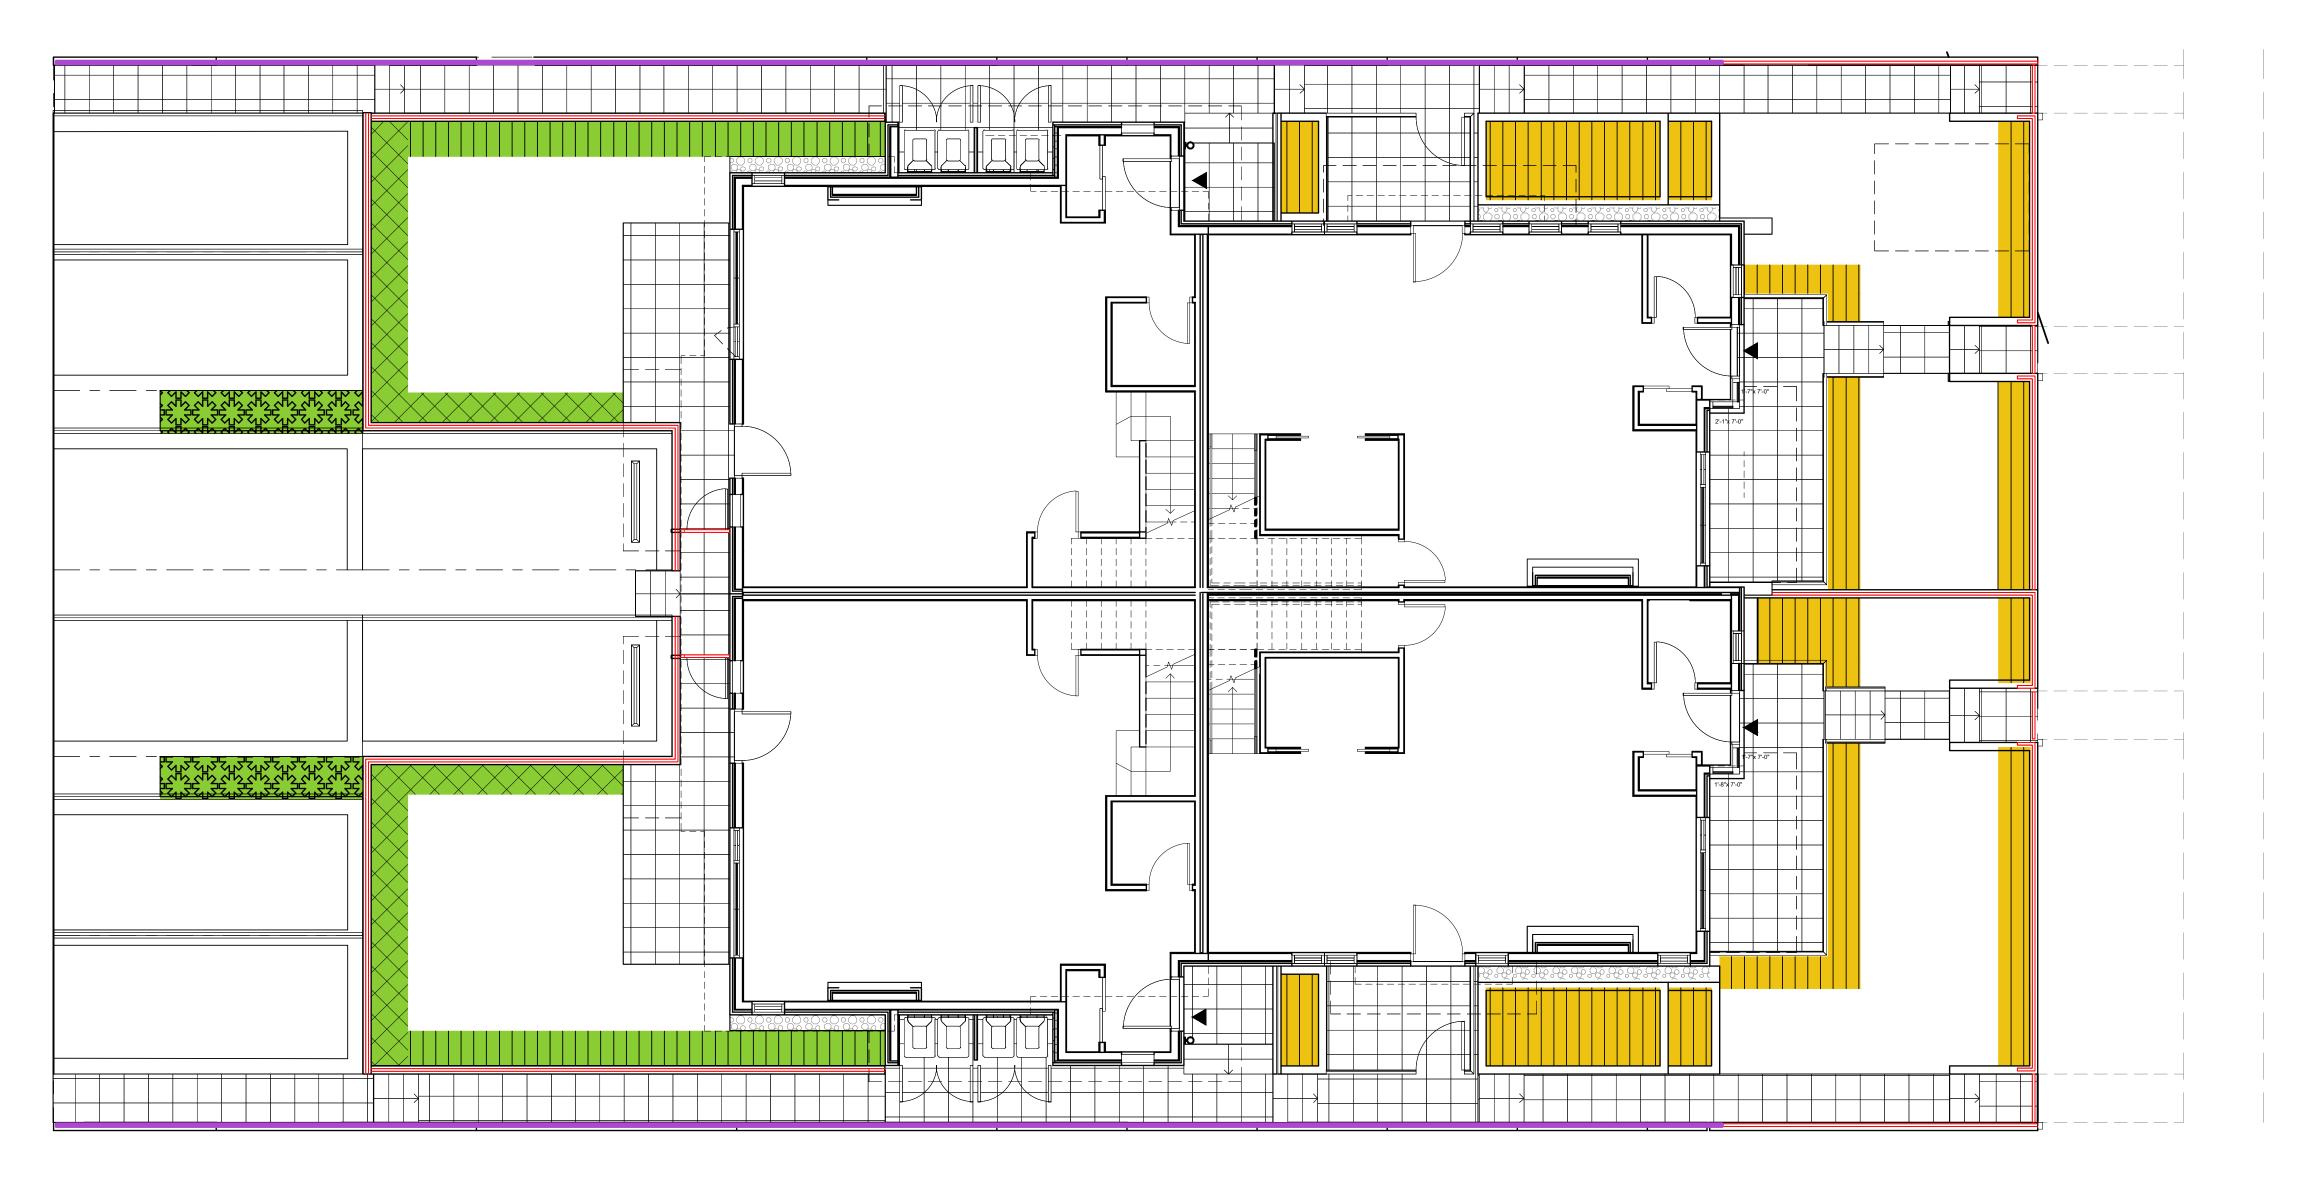

LANDSCAPE ARCHITECTS ltd.

Suite C100 - 4185 Still Creek Drive
Burnaby, British Columbia, V5C 6G9
p: 604 294-0011; f: 604 294-0022

CITY OF COQUITLAM

These plans are provided "as is" without any guarantee, representation or warranty of any kind, whether express, implied or statutory, and will require modification for use on a particular site. The City of Coquitlam (the "City") assumes no liability whatsoever with respect to your use of these plans or any errors or omissions herein. Any reliance on the accuracy, suitability, currency or completeness of the information contained in the plans is entirely at your own risk. These plans are the property of the City and may not be used, copied, reproduced or distributed in any way or for any purpose other than in connection with a City development application.

	_10	22.JAN.13	REVISE PER CITY COMMENTS	RK
	9	21.DEC.14	REVISE PER CITY COMMENTS	RK
	8	21.NOV.29	REVISE PER CITY COMMENTS	RK
	7	21.NOV.14	REVISE PER CITY COMMENTS	RK
	6	21.SEP.29	REVISE PER CITY COMMENTS	RK
	5	21.AUG.03	REVISE PER CITY COMMENTS	RK
	4	21.JUN.28	REVISE PER CITY COMMENTS	RK
se	3	21.JUN.24	REVISE PER CITY COMMENTS	RK
,	2	21.MAY.06	REVISE PER CITY COMMENTS	RK
	1	21.APR.23	REVISE PER CITY COMMENTS	RK
	NO.	DATE	REVISION DESCRIPTION	DF

FOURPLEX 1

PROJECT:

SEAL:

DRAWING TITLE:

PLANTING
TYPES





CHK'D: N

/ING NUMBER:


PLANT PALETTE FOR FULL SUN AREAS

STANDARD TREES

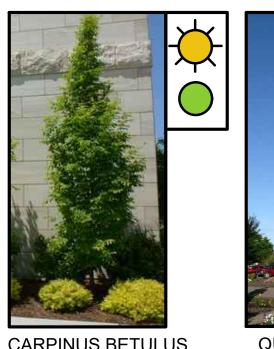


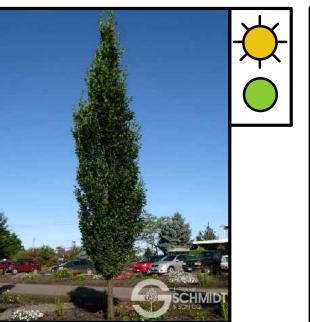


QUERCUS ROBUR ALBA 'SKINNY GENES'

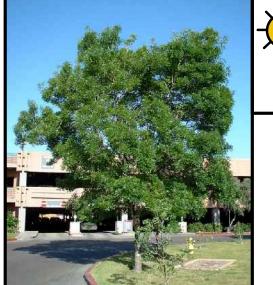

FRAXINUS ANGUSTIFOLIA 'RAYWOOD' 25' W x 30' H

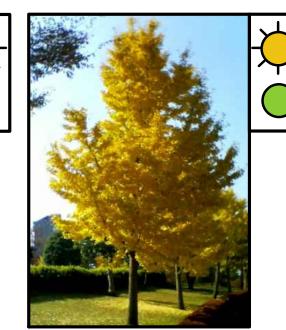


GINKGO BILOBA 'PRINCETON SENTRY' 20' W x 40' H

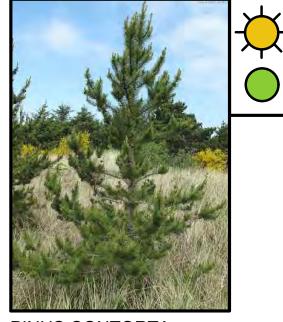

PINUS CONTORTA

ORNAMENTAL TREES 🕀

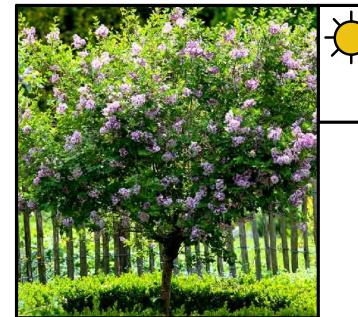


SYRINGA VULGARIS



CHIONANTHUS RETUSUS




PARROTIA PERSICA 'VANESSA'

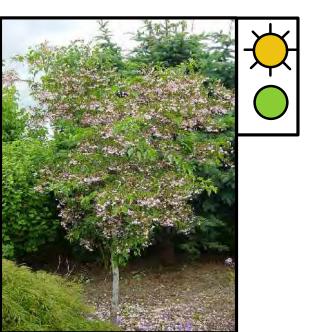

STYRAX JAPONICUS

PROPOSED SHRUBS & HEDGES

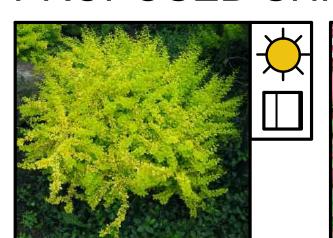

BERBERIS T. 'AUREA NANA' 3' W x 3' H



EUONYMUS 'COMPACTUS' 5' W x 5' H



FOTHERGILLA 'MOUNT AIRY'



3' W x 3' H



PHYSOCARPUS 'DART'S GOLD' 4' W x 4' H



HYDRANGEA P. 'LIMELIGHT' 5' W x 5' H



SPIRAEA JAPONICA 'GOLDMOUND' 3' W x 3' H



THUJA'SMARAGD' 2' W x 7' H




CEANOTHUS VELUTINUS



LONICERA PILEATA 5' W x 3' H




RHODODENDDRON 'CUNNINGHAM'S WHITE' 6' W x 6' H

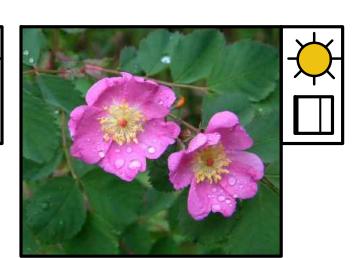


ROSA GYMNOCARPA 4' W x 4' H

LEGEND

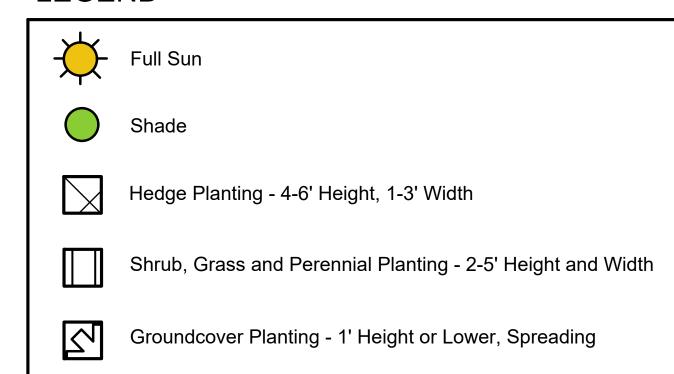


PROPOSED GRASSES/PERENNIALS/GROUNDCOVERS

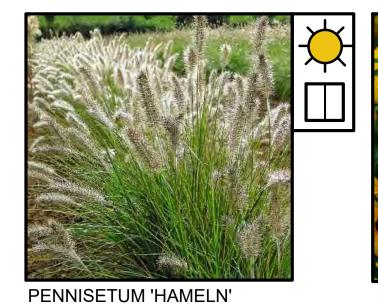


2' W x 3' H



RUDBECKIA FULGIDA 'GOLDSTURM' 2' W x 3' H

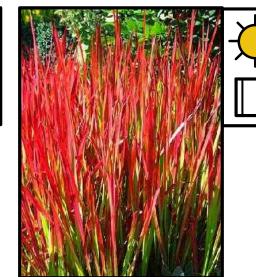

IMPERATA 'RED BARON'

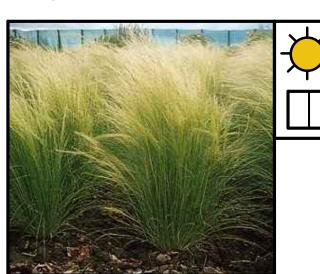


STIPA TENUISSIMA



HEMEROCALLIS 'YELLOWSTONE' 2' W x 2' H




HEUCHERA 'BERRY SMOOTHIE'

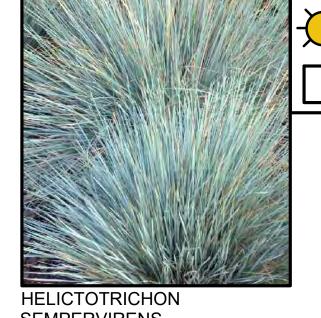

SEMPERVIRENS 2' W x 3' H



CALAMAGROSTIS 'KARL FOERSTER' 3' W x 4' H

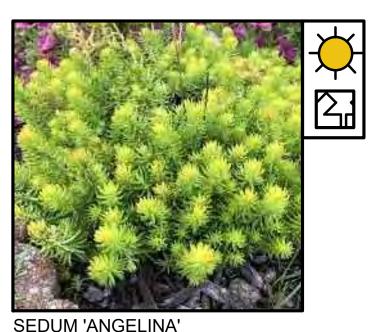

1' W x 0.5' H

Suite C100 - 4185 Still Creek Drive Burnaby, British Columbia, V5C 6G9 p: 604 294-0011; f: 604 294-0022

6' W x 6' H

CITY OF COOLIITI AM

development application.

CITY OF COQUITEAIN
These plans are provided "as is" without any
guarantee, representation or warranty of any kind,
whether express, implied or statutory, and will require
modification for use on a particular site. The City of
Coquitlam (the "City") assumes no liability whatsoever
with respect to your use of these plans or any errors or
omissions herein. Any reliance on the accuracy,
suitability, currency or completeness of the information
contained in the plans is entirely at your own risk. These
plans are the property of the City and may not be used,
copied, reproduced or distributed in any way or for any
purpose other than in connection with a City

10	22.JAN.13	REVISE PER CITY COMMENTS	R
9	21.DEC.14	REVISE PER CITY COMMENTS	R
8	21.NOV.29	REVISE PER CITY COMMENTS	R
7	21.NOV.14	REVISE PER CITY COMMENTS	R
6	21.SEP.29	REVISE PER CITY COMMENTS	R
5	21.AUG.03	REVISE PER CITY COMMENTS	R
4	21.JUN.28	REVISE PER CITY COMMENTS	R
3	21.JUN.24	REVISE PER CITY COMMENTS	R
		-	

NO. DATE REVISION DESCRIPTION DR.

2 21.MAY.06 REVISE PER CITY COMMENTS

PROJECT:

FOURPLEX 1

DRAWING TITLE:


FULL SUN PLANT PALETTE




21-058

PLANT PALETTE FOR SHADE AREAS




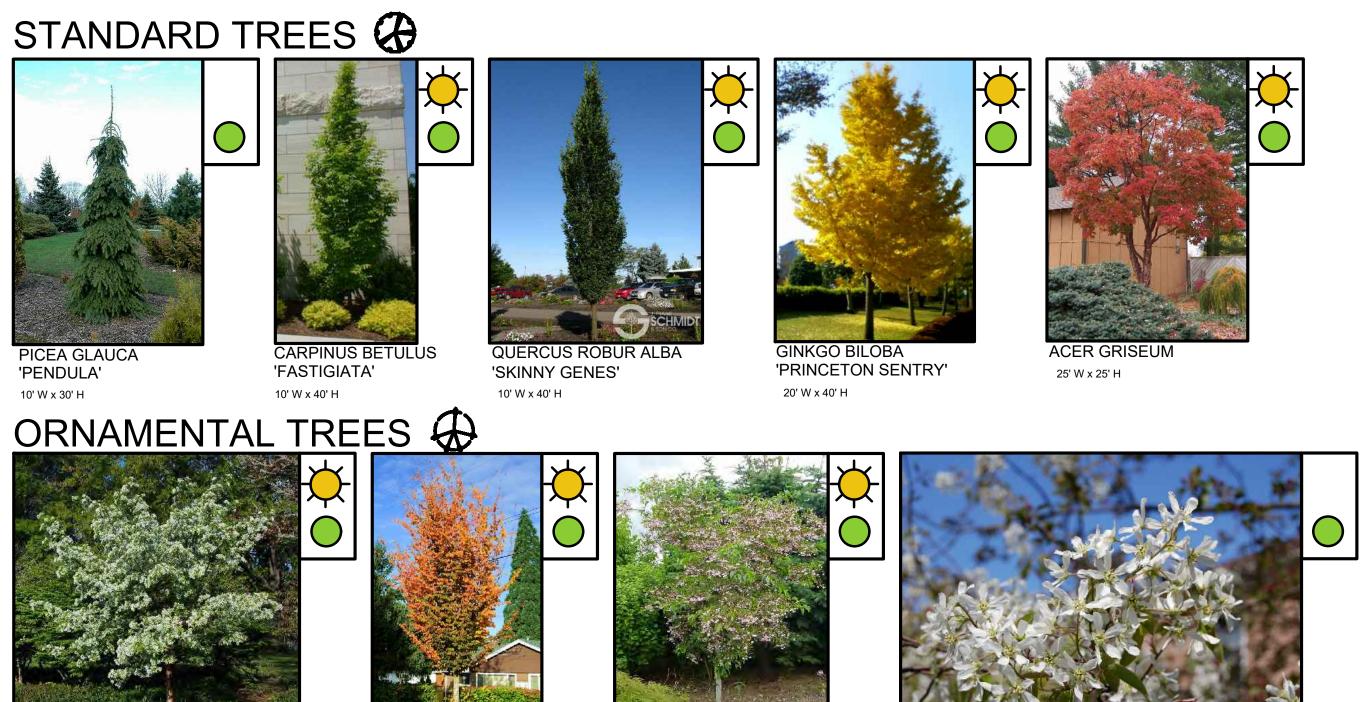

STYRAX JAPONICUS

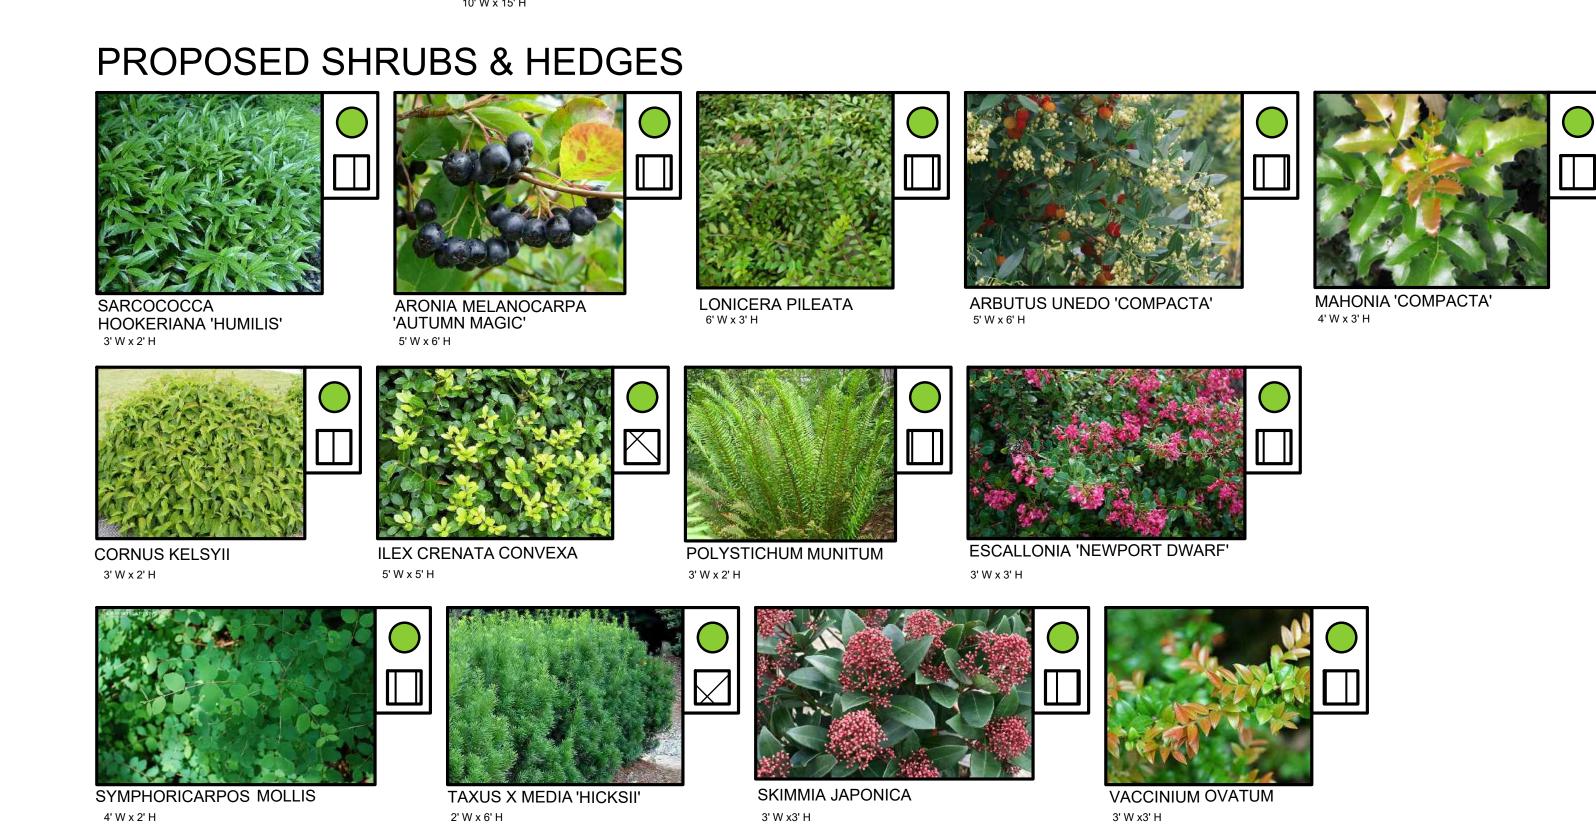

LEGEND

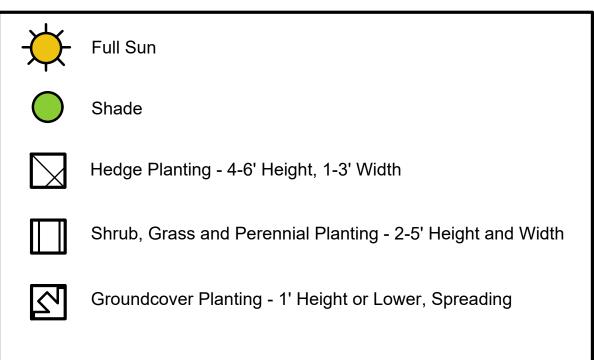

PROPOSED GRASSES/PERENNIALS/GROUNDCOVERS






OLILIVI.
CITY OF COQUITLAM
These plans are provided "as is" without any guarantee, representation or warranty of any kind, whether express, implied or statutory, and will require modification for use on a particular site. The City of Coquitlam (the "City") assumes no liability whatsoever with respect to your use of these plans or any errors or omissions herein. Any reliance on the accuracy, suitability, currency or completeness of the information contained in the plans is entirely at your own risk. These plans are the property of the City and may not be used, copied, reproduced or distributed in any way or for any

purpose other than in connection with a City

development application.

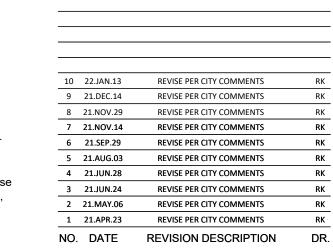

FOURPLEX 1

PROJECT:



PLANT SCHEDULE PMG PROJECT NUMBER: 21-058 S / O* C/E/D* **BOTANICAL NAME COMMON NAME** PLANTED SIZE / REMARKS **SPACING** TREES 4M O.C. ACER GRISEUM PAPERBARK MAPLE 5CM CAL; 1.2M STD; B&B 3M O.C. AMELANCHIER CANADENSIS SERVICEBERRY 5CM CAL, 1M STD, B&B 3M O.C. 5CM CAL, 1M STD, B&B CARPINUS BETULUS 'FASTIGIATA' PYRAMIDAL EUROPEAN HORNBEAM 3M O.C. CHIONANTHUS RETUSUS FRINGE TREE 6CM CAL, 1.2M STD 3M O.C. FRAXINUS ANGUSTIFOLIA 'RAYWOOD' RAYWOOD ASH 5CM CAL; 1.2M STD; B&B 4M O.C. GINKGO BILOBA 'PRINCETON SENTRY' PRINCETON SENTRY MAIDENHAIR 6CM CAL; 1.2M STD; B&B 4M O.C. PARROTIA PERSICA 'VANESSA' VANESSA PERSIAN IRONWOOD 6CM CAL, 1.2M STD 2M O.C. PICEA GLAUCA 'PENDULA' WEEPING WHITE SPRUCE 2.5M HT; B&B 4M O.C. PINUS CONTORTA SHORE PINE 2.5M HT; B&B 2M O.C. QUERCUS ROBUR ALBA 'SKINNY GENES' FASTIGIATE ENGLISH OAK 6CM CAL; 1.2M STD; B&B 4M O.C. STYRAX JAPONICA 'SNOWCONE' SNOWCONE SNOWBELL 5CM CAL, 1M STD, B&B 3M O.C. D SYRINGA VULGARIS COMMON TREE LILAC 5CM CAL, 1M STD, B&B SHRUBS #3 POT 1M O.C. ARONIA MELANOCARPA 'AUTUMN MAGIC' AUTUMN MAGIC CHOKEBERRY ARBUTUS UNEDO 'COMPACTA' COMPACT STRAWBERRY TREE #3 POT 1M O C

	ARBUTUS UNEDU CUMPACTA	COMPACT STRAWBERRY TREE	#3 POT	TIM O.C.
D	BERBERIS THUNBERGII "AUREA NANA"	GOLDEN DWARF BARBERRY	#3 POT	1M O.C.
D	CEANOTHUS VELUTINUS	SNOWBRUSH	#3 POT	1M O.C.
D	CORNUS SERICEA 'KELSEYI'	DWARF KELSEY DOGWOOD	#3 POT	600MM O.C.
Е	ESCALLONIA 'NEWPORT DWARF'	COMPACT ESCALLONIA	#3 POT	900MM O.C.
D	EUONYMUS ALATA 'COMPACTUS'	COMPACT WINGED BURNING BUSH	#3 POT	1M O.C.
D	FOTHERGILLA MAJOR 'MOUNT AIRY'	MOUNT AIRY FOTHERGILLA	#3 POT	1M O.C.
D	HYDRANGEA PANICULATA 'LIMELIGHT'	LIMELIGHT HYDRANGEA; LIMEGREEN-PINK	#3 POT	1M O.C.
E	ILEX CRENATA 'CONVEXA'	JAPANESE HOLLY	#3 POT	900MM O.C.
E	LONICERA PILEATA	PRIVET HONEYSUCKLE	#2 POT	900MM O.C.
E	MAHONIA AQUIFOLIUM 'COMPACTA'	COMPACT OREGON GRAPE	#3 POT	600MM O.C.
E	NANDINA DOMESTICA 'GULF STREAM'	HEAVENLY BAMBOO; DWARF	#2 POT	900MM O.C.
D	PHYSOCARPUS OPULIFOLIUS 'DART'S GOLD'	GOLDEN NINEBARK	#3 POT	900MM O.C.
E	POLYSTICHUM MUNITUM	SWORD FERN	#2 POT	900MM O.C.
E	RHODODENDRON 'CUNNINGHAM'S WHITE'	RHODODENDRON; WHITE; L. MAY	#3 POT	1M O.C.
D	ROSA GYMNOCARPA	BALDHIP ROSE	#3 POT	900MM O.C.
E	SARCOCOCCA HOOKERIANA 'HUMILIS'	SWEETBOX	#2 POT	900MM O.C.
E	SKIMMIA JAPONICA (90% MALE)	JAPANESE SKIMMIA	#2 POT	900MM O.C.
D	SPIRAEA JAPONICA 'GOLDMOUND'	DWARF GOLDMOUND SPIREA	#3 POT	600MM O.C.
D	SYMPHORICARPOS MOLLIS	SNOWBERRY	#3 POT	900MM O.C.
С	TAXUS X MEDIA 'HICKSII'	HICK'S YEW	1.2M HT; B&B	600MM O.C.

EMERALD GREEN CEDAR

EVERGREEN HUCKLEBERRY

VACCINIUM OVATUM

THUJA OCCIDENTALIS 'SMARAGD'

^{*}C/E/D INDICATES CONIFEROUS OR EVERGREEN OR DECIDUOUS SPECIES




CITY OF COQUITLAM These plans are provided "as is" without any quarantee, representation or warranty of any kind, whether express, implied or statutory, and will require modification for use on a particular site. The City of Coquitlam (the "City") assumes no liability whatsoever with respect to your use of these plans or any errors or omissions herein. Any reliance on the accuracy, suitability, currency or completeness of the information contained in the plans is entirely at your own risk. These plans are the property of the City and may not be used,

copied, reproduced or distributed in any way or for any

purpose other than in connection with a City

development application.

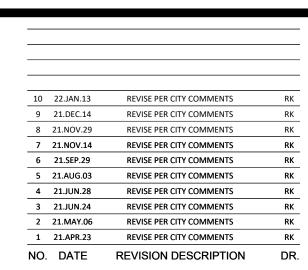

FOURPLEX 1


PROJECT:

DRAWING TITLE:

1.5M HT; B&B

#2 POT

TREE & SHRUB PLANT SCHEDULE

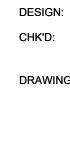

450MM O.C.

600MM O.C.

^{*}S / O INDICATES STANDARD OR ORNAMENTAL TREES

D	CALAMAGROSTIS ACUTIFLORA 'KARL FOERSTER'	FEATHER REED GRASS	#1 POT	450MM O.C.
E	CAREX OSHIMENSIS 'EVERGOLD'	EVERGOLD JAPANESE SEDGE	#1 POT	300MM O.C.
D	HAKONECHLOA MACRA 'AUREOLA'	HAKONE GRASS	#1 POT; 1 EYE	300MM O.C.
Е	HELICTOTRICHON SEMPERVIRENS	BLUE OAT GRASS	#1 POT	300MM O.C.
D	IMPERATA CYLINDRICA 'RED BARON'	BLOOD GRASS	#1 POT	300MM O.C.
D	PENNISETUM ALOPECUROIDES 'HAMELIN'	DWARF FOUNTAIN GRASS	#1 POT	300MM O.C.
D	STIPA TENUISSIMA	MEXICAN FEATHER GRASS	#1 POT	300MM O.C.

PERENNIALS

D	ASTILLBE ARENDSII	FALSE GOATSBEARD	#1 POT; 1 EYE	300MM O.C.
Е	BRUNNERA MACROPHYLLA	SIBERIAN BUGLOSS	#1 POT; 1 EYE	300MM O.C.
D	HELLEBORUS X HYBRIDUS	HELLEBORE	#1 POT; 1 EYE	300MM O.C.
Е	HEMEROCALLIS 'YELLOWSTONE'	DAYLILY; LIGHT YELLOW	#2 POT; 2-3 FAN	300MM O.C.
D	HEUCHERA 'BERRY SMOOTHIE'	ROSE PINK HEUCHERA	#1 POT	300MM O.C.
D	HOSTA 'AUGUST MOON'	HOSTA	#1 POT; 1 EYE	300MM O.C.
D	RUDBECKIA FULGIDA VAR SULLIVANTII `GOLDSTURM'	RUDBECKIA; YELLOW	#1 POT	300MM O.C.
Е	SEDUM 'ANGELINA'	ANGELINA STONECROP	#1 POT	300MM O.C.

GROUNDCOVERS

300MM O.C. ARCOSTAPHYLOS UVA URSI KINNICKINICK #1 POT; 1 EYE

*C/E/D INDICATES CONIFEROUS OR EVERGREEN OR DECIDUOUS SPECIES

Suite C100 - 4185 Still Creek Drive

Burnaby, British Columbia, V5C 6G9 p: 604 294-0011; f: 604 294-0022

CITY OF COQUITLAM These plans are provided "as is" without any

guarantee, representation or warranty of any kind, whether express, implied or statutory, and will require modification for use on a particular site. The City of Coquitlam (the "City") assumes no liability whatsoever with respect to your use of these plans or any errors or omissions herein. Any reliance on the accuracy, suitability, currency or completeness of the information contained in the plans is entirely at your own risk. These plans are the property of the City and may not be used, copied, reproduced or distributed in any way or for any purpose other than in connection with a City development application.


10 22.JAN.13 REVISION DESCRIPTION


FOURPLEX 1


PROJECT:

DRAWING TITLE:

DATE:

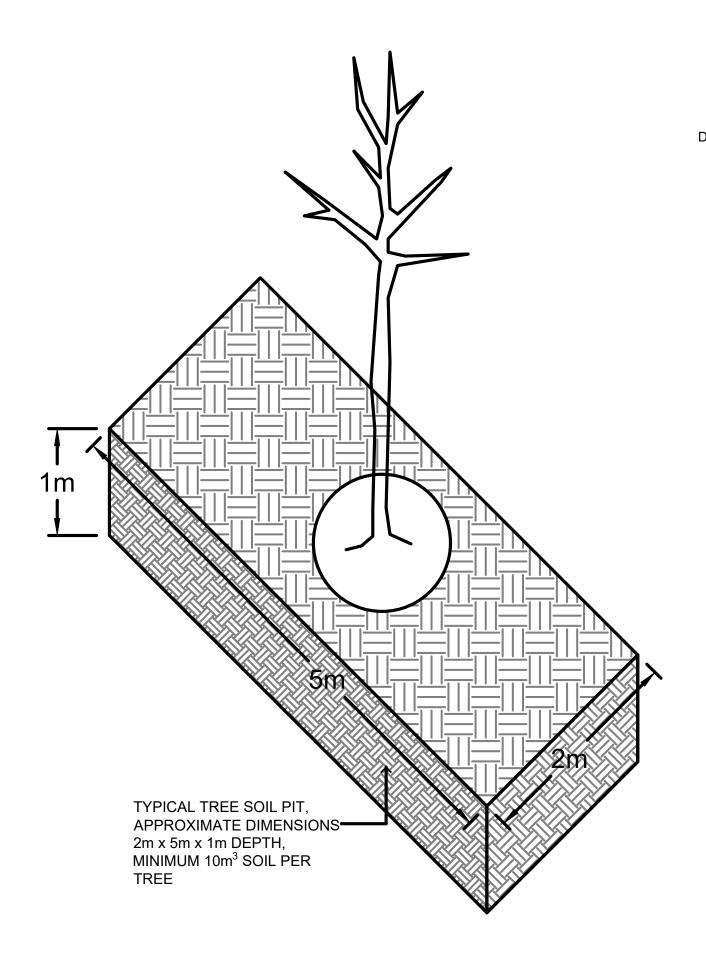

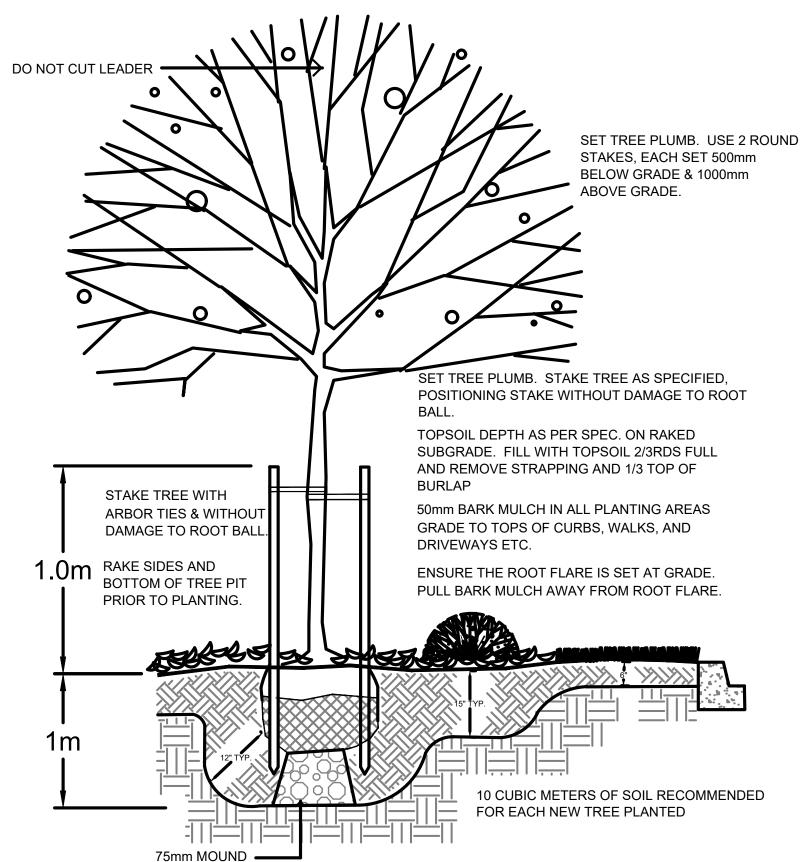

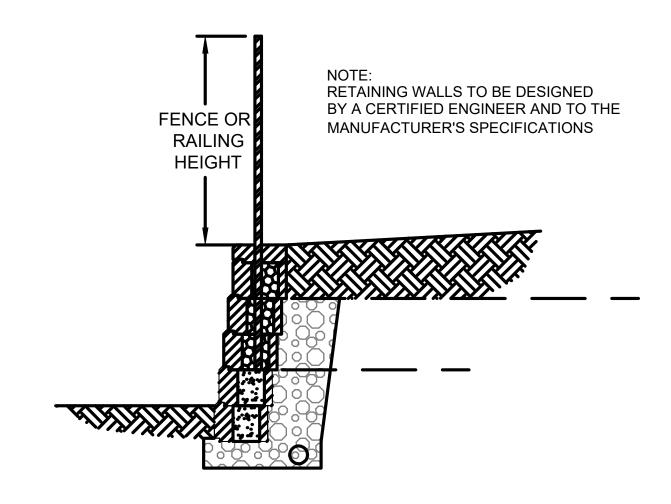


TREE PLANTING DETAIL

1:100


TYPICAL ALLAN BLOCK WALL DETAIL

MIN. 75mm OF COMPOSTED BARK MULCH AS PER SPECIFICATION APPLIED SPREAD ROOTS EVENLY OVER COMPACTED MOUND OF TOPSOIL. PRUNE ALL DAMAGED ROOTS LEAVING ROOT TIPS WITH CLEAN FINISHED GRADE BACKFILL SOIL MIX AS PER SPECIFICATION MIN. 450mm DEPTH _SHRUB BED TO BE MIN 450mm **CONTAINER** MULCH TO BE 75mm DEEP AT DRIP LINE. TAPERING TO 0mm AT TRUNK FLARE.

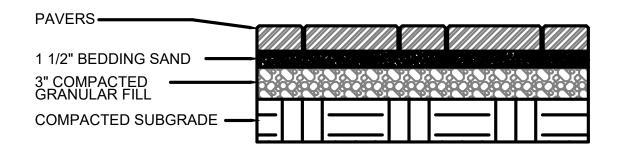

NOTE: PAVERS TO BE INSTALLED TO MANUFACTURERS SPECIFICATIONS

TYPICAL PAVERS ON GRADE DETAIL

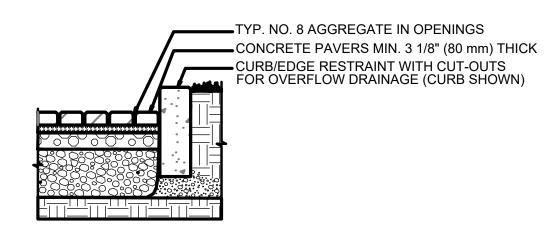

NOTES: 1. 2 3/8" (60 MM) THICK PAVERS MAY BE USED IN PEDESTRIAN APPLICATIONS. 2. NO. 2 STONE SUBBASE THICKNESS VARIES WITH DESIGN. 3. FOLLOW MANUFACTURER'S INSTALLATION RECOMMENDATIONS. 4. AS EACH SITE VARIES, CONSULT A CIVIL ENGINEER FOR PAVING/WALL SUBGRADE.

BARE ROOT/CONTAINER SHRUB PLANTING

LOOSEN ROOT MASS PRIOR TO PLANTING.

TYPICAL PERMEABLE PAVERS DETAIL **L7**

LANDSCAPE ARCHITECTS Suite C100 - 4185 Still Creek Drive Burnaby, British Columbia, V5C 6G9

p: 604 294-0011; f: 604 294-0022

CITY OF COQUITLAM

These plans are provided "as is" without any guarantee, representation or warranty of any kind, whether express, implied or statutory, and will require modification for use on a particular site. The City of Coquitlam (the "City") assumes no liability whatsoever with respect to your use of these plans or any errors or omissions herein. Any reliance on the accuracy, suitability, currency or completeness of the information contained in the plans is entirely at your own risk. These plans are the property of the City and may not be used, copied, reproduced or distributed in any way or for any purpose other than in connection with a City

development application.

10 22.JAN.13 REVISE PER CITY COMMENTS 3 21.NOV.29 7 21.NOV.14 5 21.AUG.03 4 21.JUN.28 NO. DATE REVISION DESCRIPTION

FOURPLEX 1

PROJECT:

LANDSCAPE DETAILS

DRAWING TITLE:

CHK'D:




1:100

DRAWING NUMBER:

PMG PROJECT NUMBER:

21-058

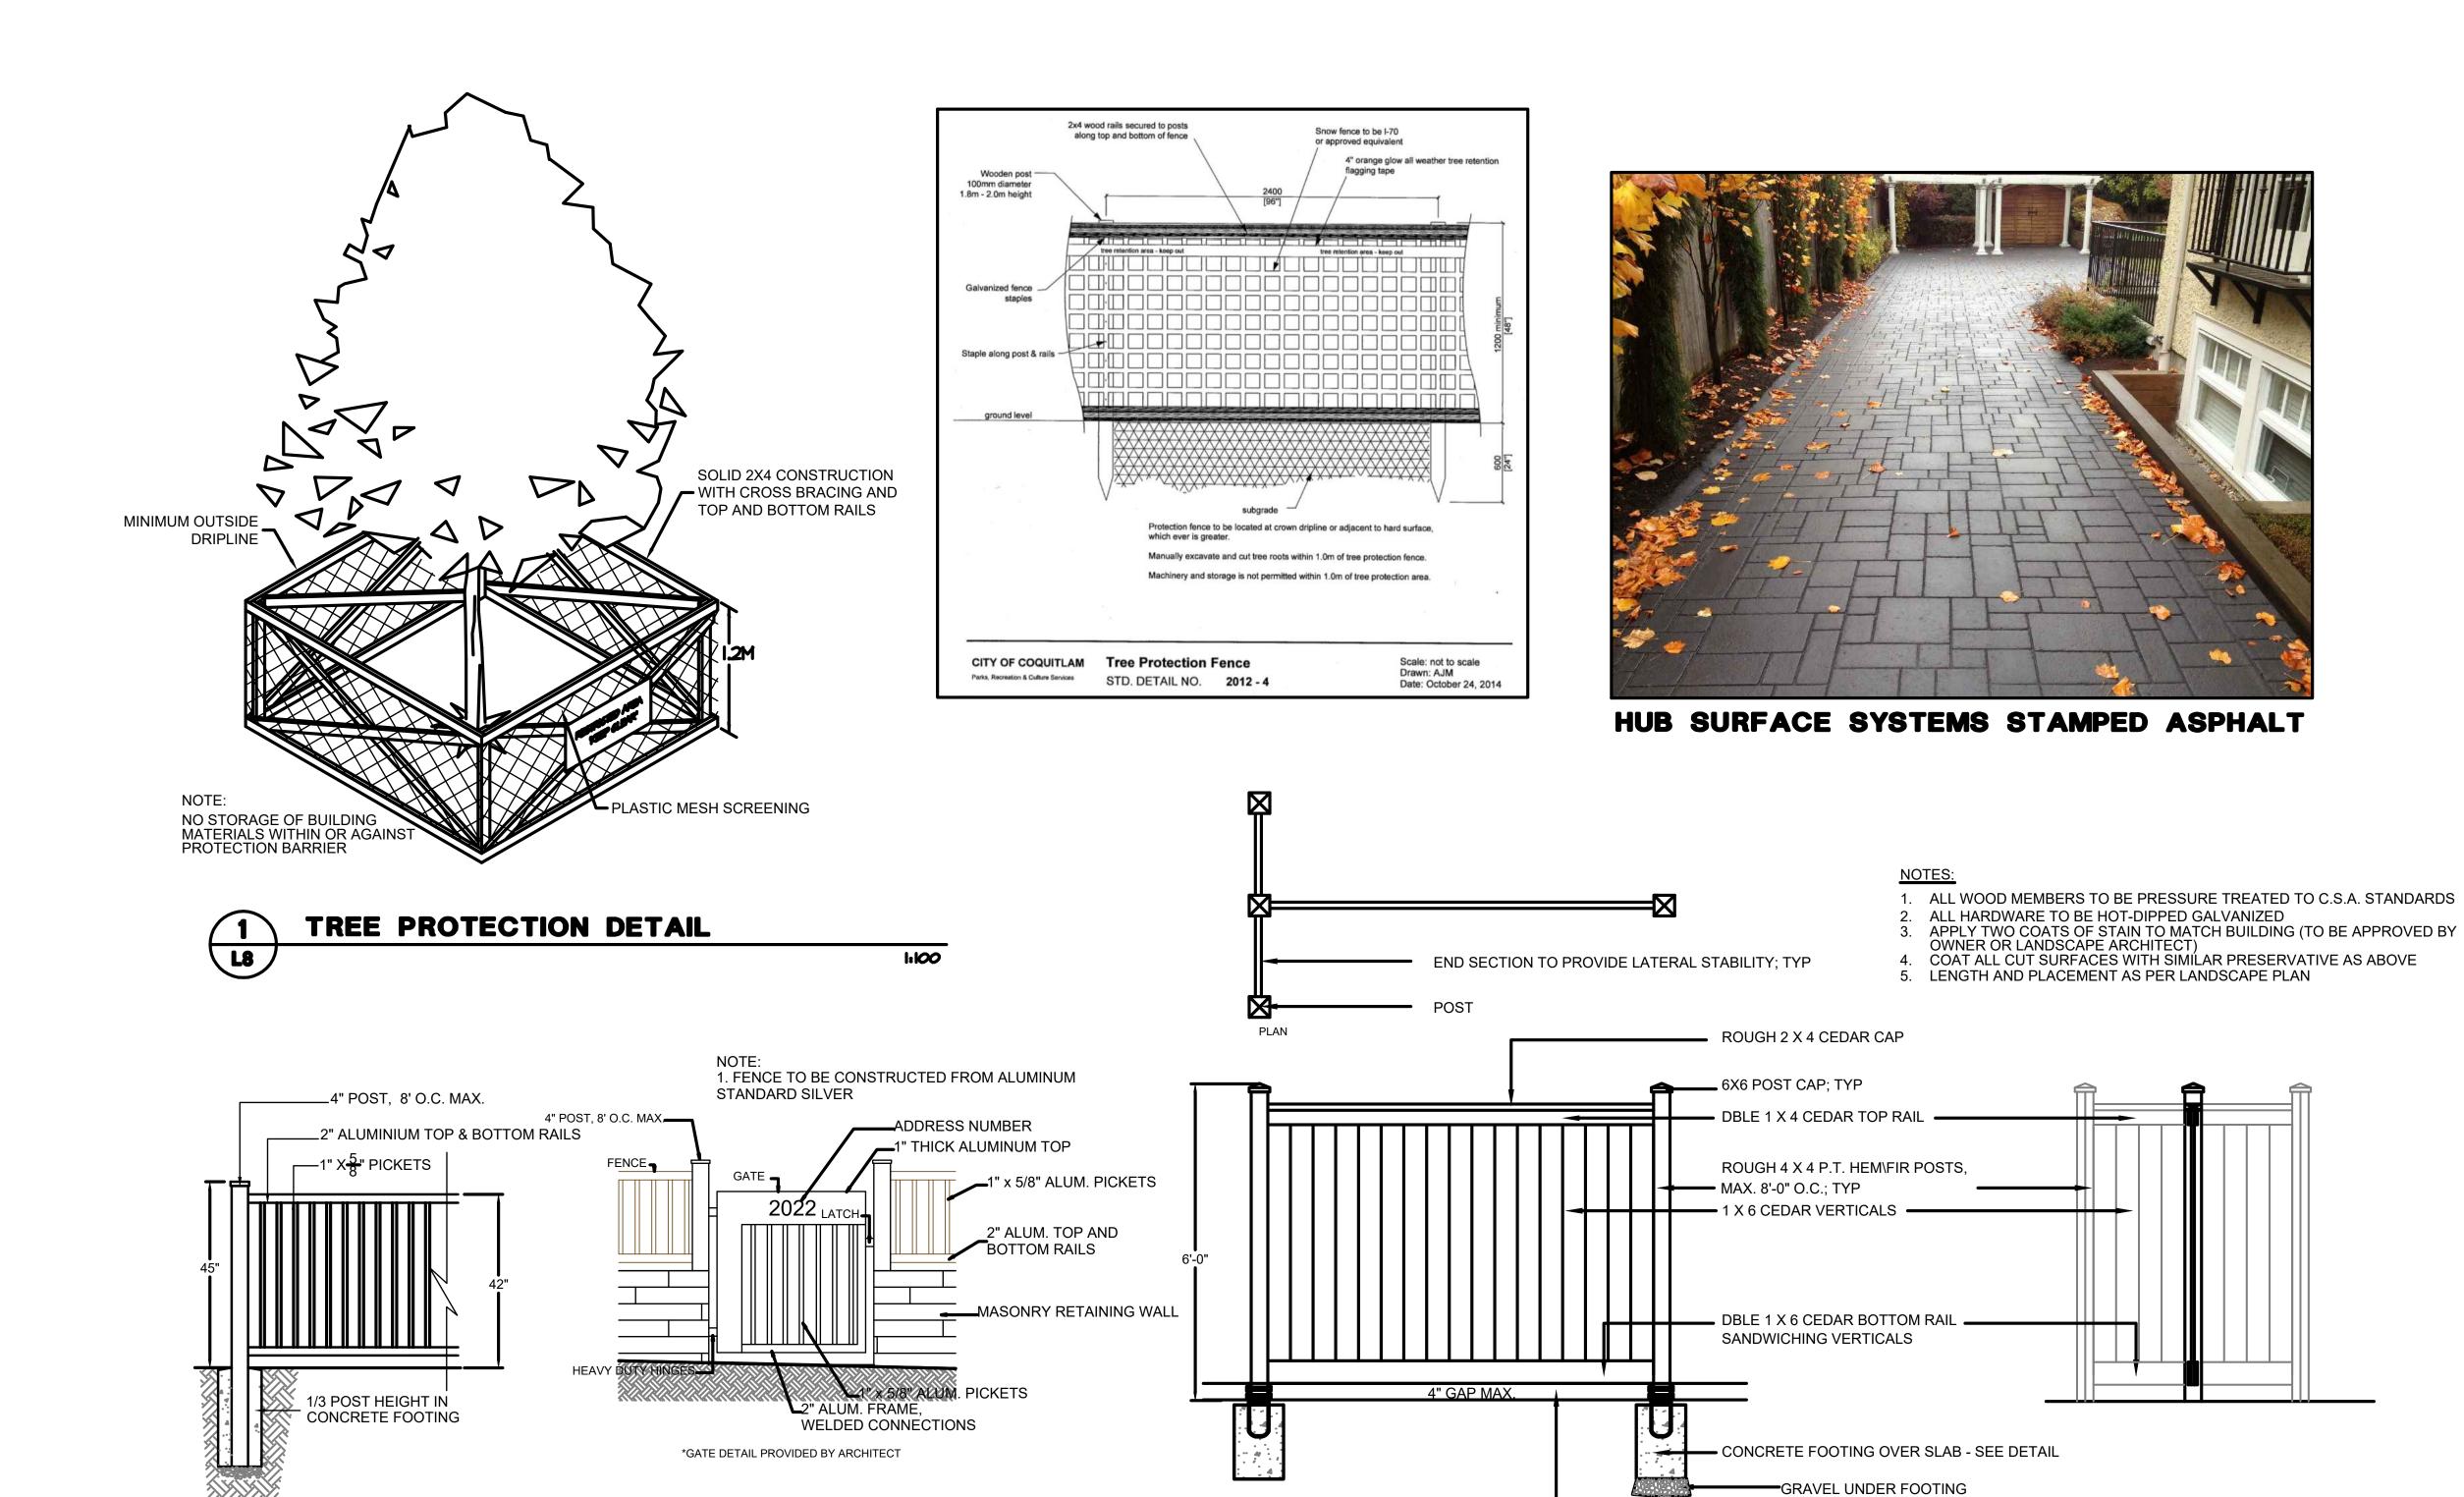

1.2m HEIGHT FENCE AND GATE

1.8m HEIGHT FENCE AND GATE

1.8m HEIGHT FENCE AND GATE

1.8m HEIGHT FENCE AND GATE

SIDE ELEVATION

LANDSCAPE ARCHITECTS (ltd.)

Suite C100 - 4185 Still Creek Drive
Burnaby, British Columbia, V5C 6G9
p: 604 294-0011; f: 604 294-0022

CITY OF COQUITLAM These plans are provided "as is" without any 10 22.JAN.13 REVISE PER CITY COMMENTS guarantee, representation or warranty of any kind, whether express, implied or statutory, and will require modification for use on a particular site. The City of 8 21.NOV.29 Coquitlam (the "City") assumes no liability whatsoever 7 21.NOV.14 REVISE PER CITY COMMENTS with respect to your use of these plans or any errors or 6 21.SEP.29 REVISE PER CITY COMMENTS omissions herein. Any reliance on the accuracy, 5 21.AUG.03 suitability, currency or completeness of the information contained in the plans is entirely at your own risk. These plans are the property of the City and may not be used, copied, reproduced or distributed in any way or for any 1 21.APR.23 REVISE PER CITY COMMENTS purpose other than in connection with a City development application. NO. DATE REVISION DESCRIPTION DR.

UNIT FENCES

UNIT GATES

FOURPLEX 1

PROJECT:

LANDSCAPE DETAILS 2

DRAWING TITLE:

END ELEVATION

WHERE GRADE IS MORE THAN 6"

TO 4" ABOVE GRADE

BELOW BOTTOM RAIL, EXTEND KICKER

DATE: 21.APR.C

SCALE: AS NOTE

DRAWN: RK

DESIGN: RK

CHK'D: MCY

DRAWING NUMBER:

PMG PROJECT NUMBER:

21-058

1.1 SCOPE OF WORK

- 1. Work includes supply of all related items and performing all operations necessary to complete the work in accordance with the drawings and specifications and generally consists of the following:
- Retention of Existing Trees where shown on drawings.
- Finish Grading and Landscape Drainage.
- Supply and placement of growing medium.
- Preparation of planting beds, supply of plant material and planting.
- Preparation of lawn areas, supply of materials and sodding.
- Supply and placement of bark mulch.
- 1.2 Growing Medium: Conform to Canadian Landscape Standard for definitions of imported and on-site topsoil.

TABLE ONE: PROPERTIES OF GROWING MEDIUM FOR LEVEL 2 GROOMED AREAS Canadian System of Soil Classification Textural Class: "Loamy Sand" to "Sandy Loam".

<u> </u>				
Applications	Planting Areas			
	and Planters			
Growing Medium Types	2P			
Texture Percent O	f Dry Weight of Total Growing Medium			
Coarse Gravel: larger than 25mm	0 - 1%			
All Gravel: larger than 2mm	0 - 5%			
Percent Of Dry Weight of Growing Medium Excluding Grav				
Sand: larger than 0.05mm smaller than 2.0mm	40 - 80%			
Silt: larger than 0.002mm smaller than 0.05mm	10 - 25%			
Clay: smaller than 0.002mm	0 - 25%			
Clay and Silt Combined	maximum 35%			
Organic Content (coast):	10 - 20%			
Organic Content (interior):	15 - 20%			
Acidity (pH):	4.5 - 6.5			
· · · · · · · · · · · · · · · · · · ·				

1.3 RETENTION OF EXISTING TREES

- .1 Prior to any work on site protect individual trees or plant groupings indicated as retained on landscape plans as vegetation retention areas.
- .2 A physical barrier must be installed to delineate clearing boundaries. Refer to physical barrier detail. If detail not provided, comply with local municipal requirements.
- .3 No machine travel, storage, or parking within vegetation retention areas or under crowns of trees to be retained is allowed.
- .4 No excavations, drain or service trenches nor any other disruption shall be permitted within vegetation retention areas.
- .5 Do not cut branches or roots of retained trees if possible, any pruning of the branches and/or roots of retained trees should be done in accordance to arboricultural best management practices.

1.4 GRADES

.1 Eliminate standing water from all finished grades. Provide a smooth, firm and even surface in paved areas.

1.5 LAWN AREAS - SODDING

- .1 Specified Turfgrass for sod lawn areas includes Kentucky Blue for sun and Fescues for shade.
- .2 Sodding: Prepare a smooth, firm, even surface for laying sod. Lay sod staggered with sections closely butted, without overlapping or gaps, smooth and even with adjoining areas and roll lightly. Water to obtain moisture penetration of 3" to 4" (7 - 10cm).



CITY OF COQUITLAM guarantee, representation or warranty of any kind, whether express, implied or statutory, and will require modification for use on a particular site. The City of Coquitlam (the "City") assumes no liability whatsoever with respect to your use of these plans or any errors or omissions herein. Any reliance on the accuracy, suitability, currency or completeness of the information contained in the plans is entirely at your own risk. These plans are the property of the City and may not be used, copied, reproduced or distributed in any way or for any

purpose other than in connection with a City

development application.

REVISE PER CITY COMMENTS REVISE PER CITY COMMENTS REVISE PER CITY COMMENTS 3 21.JUN.24 REVISION DESCRIPTION

FOURPLEX 1

PROJECT:

LANDSCAPE **SPECIFICATIONS**

DRAWING TITLE

21058-10.ZIP

1.6 PLANTS AND PLANTING

- .1 Conform to planting layout as shown on Landscape Plans.
- .2 Make edge of beds with smooth clean defined lines.
- .3 Standards:
 - .1 Refer to Plant Schedule for specific plant and container sizes and comply with requirements.
 - .2 Plant material obtained from areas with less severe climatic conditions shall be grown to withstand the site climate.
- .4 Plant Species & Location:
 - .4.1 Plants shall be true to name and of the height, caliper and size of root ball as shown on the landscape/site plan plant schedule. Caliper of trees is to be taken 6" (15cm)
 - .4.2 Plant all specified species in the location as shown on the landscape drawings.
- .5 Excavation:
 - .5.1 Trees and large shrubs: Excavate a saucer shaped tree pit to the depth of the rootball and to at least twice the width of the rootball. Assure that finished grade is at the original grade the tree was grown at.
- .6 Drainage of Planting Holes:
 - .6.1 Provide drainage of planting pits where required. ie. on sloped conditions, break out the side of the planting pit to allow drainage down slope; and in flat conditions, mound to raise the rootball above impervious layer.
- Planting and Fertilizing Procedures:
 - .7.1 Plant all trees and shrubs with the roots placed in their natural growing position. If burlapped, loosen around the top of the ball and cut away or fold under. Do not pull burlap from under the ball. Carefully remove containers without injuring the rootballs. After settled in place, cut twine. For wire baskets, clip and remove top three rows of wire.
 - .7.2 Fill the planting holes by gently firming the growing medium around the root system in 6" (15cm) layers. Settle the soil with water. Add soil as required to meet finish grade. Leave no air voids. When 2/3 of the topsoil has been placed, apply fertilizer as recommended by the required soil test at the specified rates.
 - .7.3 Where planting is indicated adjacent to existing trees, use special care to avoid disturbance of the root system or natural grades of such trees.
 - .7.4 Where trees are in lawn areas, provide a clean cut mulched 900mm (3 ft.) diameter circle centered on the tree.
- .8 Staking of Trees if Necessary:
 - .8.1 Use two 2"x2"x5' stakes, unless superseded by municipal requirements. Set stakes minimum 2 ft. in soil. Do not drive stake through rootball.
 - .8.2 Leave the tree carefully vertical.
 - .8.3 Tie with pre-approved commercial, flat woven polypropylene fabric belt, minimum width 19mm (3/4"). Approved product: ArborTie available from DeepRoot.
 - Coniferous Trees over 6 ft. height: Guy with three 2-strand wires (11 gauge). Drive three stakes equidistant around the tree completely below grade.
- .9 Pruning:
 - .9.1 Limit pruning to the minimum necessary to remove dead or injured branches. Preserve the natural character of the plants, do not cut the leader. Use only clean, sharp tools. Make all cuts clean and cut to the branch collar leaving no stubs. Shape affected areas so as not to retain water. Remove damaged material. Follow arboricultural best management practices.
- .10 Mulching:
 - .10.1 Mulch all planting areas with an even layer of mulch to 2-1/2 3" (65 75mm) depth. Confirm placement of mulch in areas labeled "Groundcover Area" on drawings. Mulch a 3 ft. (900mm) diameter circle around trees in lawn areas, leave a clean edge. Pull mulch away from base of tree trunk.

1.7 ESTABLISHMENT MAINTENANCE

.1 Required maintenance of the landscape includes watering, weeding, mowing, leaf removal and fertilization.

Burnaby, British Columbia, V5C 6G9

p: 604 294-0011; f: 604 294-0022

CITY OF COQUITLAM These plans are provided "as is" without any guarantee, representation or warranty of any kind, whether express, implied or statutory, and will require modification for use on a particular site. The City of Coquitlam (the "City") assumes no liability whatsoever with respect to your use of these plans or any errors o omissions herein. Any reliance on the accuracy, suitability, currency or completeness of the information contained in the plans is entirely at your own risk. These plans are the property of the City and may not be used, copied, reproduced or distributed in any way or for any purpose other than in connection with a City

development application

8 21.NOV.29 REVISE PER CITY COMMENT REVISE PER CITY COMMEN 3 21.JUN.24 REVISION DESCRIPTION

FOURPLEX 1

PROJECT

SPECIFICATIONS

21058-10.ZIP

DRAWING TITLE